

TOWN OF MILFORD, NH OFFICE OF COMMUNITY DEVELOPMENT

1 UNION SQUARE, MILFORD, NH 03055 TEL: (603)249-0620

WEB: WWW.MILFORD.NH.GOV

Date: May 22, 2019

To: Planning Board

From: Lincoln Daley, Community Development Director

Subject: Family Dental Care of Milford for the property located at Tax Map 19, Lot 13, 150 Elm Street and Tax Map 19, Lot 14, 154 Elm Street. Public hearing for a Major Site Plan application to construct a 5,400 square foot addition to the existing 2,400 square foot dental office and related parking, landscaping, lighting, and drainage improvements within in the Commercial District and Nashua-Elm Street Overlay District.

BACKGROUND/PROPOSAL:

The applicant is before the Planning Board for a Major Site Plan application to construct a 5,400 square foot addition to the existing 2,400 square foot dental office and related parking, landscaping, lighting, and drainage improvements. The proposal calls for the razing of the two exiting residential homes and lot consolidation of the two properties. The property is located in the Commercial District and the Nashua/Elm Street Overlay District. This will be the first public hearing for the project. The applicant was last before the Planning Board on April 23, 2019 for a conceptual review. At that meeting, the Board and applicant discussed the site layout, building elevations, landscaping and pedestrian connectivity. Attached please find is the site plan, waiver request narrative, and proposed elevations.

EXISTING USE/CONDITIONS:

Map 19, Lot 13 consists of a partially developed lot containing a single-family house totaling 38,559 square feet with 147 linear feet of frontage on Elm Street. The property is located adjacent to the dental practice to the west, the Pan Am Railway to the south, and a mixture of residential and commercial uses to the north and east. The property is primarily comprised of an open yard with minimal tree coverage around the perimeter.

Map 19, Lot14 consists of the 2,400 square foot dental practice and a single-family residence and is partially developed. The area of lot totals 25,850 square feet with 100.24 linear feet of frontage on Elm Street. The property is located adjacent to the auto parts retail store to the west, the Pan Am Railway to the south, and a mixture of residential and commercial uses to the north and east.

Based on the application, a wetland delineation was not performed as part of the submittal. However, in reviewing the past site plan application, no wetland resource areas were identified on the property. The topography for both lots is primarily flat with a slight upward slope from west to east.

LOT AREA:

Proposed Tax Map 6, Lot $14-1 = \pm 1.232$ acres (58,289 sq.ft.)

APPLICATION STATUS:

The application is complete and ready to be accepted.

NOTICES:

Notices were sent to all property abutters on February 15, 2019.

WAIVERS:

1. Waiver request from the Zoning Ordinance, Section 6.05.6.D.2.b seeking relief to orient the main the main entrance

in the rear of the building away from the public street.

- 2. Waiver request from the Zoning Ordinance, Section 6.05.6.C.3 seeking relief to locate the building addition 70 feet from the edge of the front property line.
- 3. Waiver request from the Zoning Ordinance, Section 6.06.6.A.2 seeking relief from Development Review Process and allow acceptance of the final formal site plan application.

ZONING DISTRICTS:

The proposed parcel lies within the Commercial 'C' district. The intent of this District is to provide areas for those businesses, institutional, financial, governmental and compatible residential uses which constitute the commercial requirements of the Town. The proposed subdivided property meets the 20,000 square foot minimum size for lots serviced by municipal water and sewer and contains at least 150 linear feet of frontage on Elm Street. A dental office is a permitted use in the Commercial zoning district.

The property also falls within the Nashua and Elm Street Overlay District. The purpose of this Ordinance is to implement the Town of Milford's vision for the future as set forth in the Community Character Chapter of the Master Plan 2007 Update: Goal No. 2: Foster the traditional character of Milford's neighborhoods by encouraging a human scale of development that is similar in setbacks, size and height, and that is comfortable and safe for pedestrians and non-motorized vehicles while allowing for an efficient and safe roadway network.

The property falls outside of the groundwater protection district and the 100-year flood hazard area, but lies within the Groundwater Protection Level 1 District.

TRAFFIC AND ACCESS MANAGEMENT:

Access and egress from the dental practice will be from a two existing curb cuts on Elm Street. The entrance located on the western portion of the property is allow for access and egress from the site. The easterly driveway is proposed to be a single vehicle, one way entrance into the site. The site layout allows for full access to the parking areas and circulation around the building. The location of the property on elm street and driveway layout provide sufficient sight distance. However, the applicant should clarify if the proposed landscaping will impede sight distance for vehicles leaving the site and vehicles traveling on Elm Street.

PARKING:

The project proposes to provide 48 total parking spaces where 40 spaces area required. The additional spaces were included to reflect demand during shift changes. The calculation is based on the number of practitioners and employees for the dental practice.

6 Total Future Practitioners x 4 = 24 spaces required (4 spaces per practitioners)

<u>32 total employees / 2 = 16 spaces required</u> (One space per every two employees)

40 spaces required

DRAINAGE/STORMWATER MANAGEMENT:

The stormwater and drainage design has been reviewed by the Town Engineering Consultant, KV Partners. See attached review dated 2/8/19.

UTILITES:

The dental office building and addition will be serviced by municipal water and sewer. Power to the site will be underground.

INTERDEPARTMENTAL REVIEWS:

Ambulance: No comments.

Assessing: No comments.

Building Department: No comments.

Code Enforcement/ Health: No comments.

Conservation Commission: See attached comments dated 5/21/19.

Environmental Programs/Stormwater: See letter from the Town engineering consultant, KV Partners dated May 23, 2019.

Fire Department: No comments.

Heritage Commission: No comments.

Police Department: No comments.

Public Works: The comments submitted to the Department involve the amount and location of the proposed landscaping and potential impact on the sight distance for vehicles leaving the site.

Water/Sewer Utilities: The comments submitted to the Department involve providing more detailed information involving the installation/connection of the municipal water and sewer lines to the building and removal of the existing lines to both homes.

Community Development / Planning:

- 1. Sheet 1. Please revise the plan to include signature blocks for the Planning Board and Property Owner and resubmit.
- 2. Sheet 1. Waiver Requests. Recommend incorporating the Waiver Requests Block into a general Notes block.
- 3. Further, please add the following notes:
 - a. A note indication that the project is subject to Police Impact Fees.
 - b. Sheet 2. Please revise the plan by addition a note stating the properties lie within the Groundwater Protection Level 1 District.
 - c. Sheet 2. Please revise the plan by revising Note 4 to state that the properties are subject the design and performance standards of the Nashua Elm Street Overlay District.
- 4. Sheet 3, Landscape Maintenance. Please clarify the method of irrigating the landscaping elements.
- 5. Sheet 3, Landscape Maintenance. Please add a note to the plan stating the following, "Any landscape element that dies, or is otherwise removed, shall be promptly replaced with the same, if not similar to, height or texture element as originally intended. In addition, landscaped areas shall be kept free of all debris, rubbish, weeds and overgrown turf grass."
- 6. Sheet 4. Signage. The plans states that the existing free standing sign will be relocated. The plans further state that the proposed sign plan to be completed by another party. Please revise the plans to include any/all monument, directory, wall, and direction signage and their associated design, construction, and engineering details.
- 7. Sheet 4, Dumpster Screening. Please revise the plans by include the design and construction details for fencing and gate around the perimeter of the dumpster and pad.
- 8. Sheet 4. The Zoning Ordinance, Section 6.05.6.B.1.a states that all projects subject shall construct wherever feasible interconnecting driveways to adjacent properties or provide secure future connections through easements to adjacent property boundaries. Please explain why the project does not contain interconnecting driveways to abutting parcels.
- 9. Sheet 4. The Zoning Ordinance, Section 6.05.6.B.1.c, requires that interior parking lots shall provide for shared use and interconnected drives. Please revise the plans or submit a waiver request.
- 10. Sheet 4. The Zoning Ordinance, Section 6.05.6.B.1.b. requires that new access points onto Nashua or Elm streets shall only be created when it is not feasible to combine or share existing access points. Please explain why the project contains two access points. What alternatives were considered for eliminating one of the access points?
- 11. Sheet 4. The Zoning Ordinance, Section 6.05.6.C.3 Build-to-Zone states that new structures shall be constructed so as to maintain a traditional streetscape edge. Further, the setbacks of adjacent structures and context of spacing between buildings shall be considered in determining the appropriate building setback. At a minimum, a new

structure shall be constructed within a Build-to-Zone between 15' and 35' from the public street right of way. If site circumstances dictate a new structure may be constructed within 10' of the public street right of way.

The proposed addition will be located outside of the required Build-to-Zone and setback. The applicant submitted a waiver request for relief from this requirement stating that the addition is approx. 70 feet from the Elm Street ROW due to the existing location of the building in the rear of the lot. Further, the addition is "L" shaped and allows for existing functioning treatment rooms to share needed equipment, resources, and space. Lastly, the proposed building is the same/similar distance as the abutting Auto Store. See waiver request.

Staff supports the waiver request given that the project is an expansion of the existing building situated in the rear of the property.

12. Sheet 4. The Zoning Ordinance, Section 6.05.6.D.2.b Building Orientation states that buildings shall be sited so that entrances are clearly identifiable and directly accessible from a sidewalk and shall be accessible for pedestrians, bicyclists and future public transit users. The applicant submitted a waiver request for relief from this requirement to locate/orient the entrance to the rear of the building. See waiver request.

Staff supports the waiver request given that the project is an expansion of the existing building and not a new structure. The location and orientation of the entrance is based on the existing building design.

- 13. Sheet 7. Pursuant to Section 6.08.8.A of the Development Regulations, please confirm that all plant stock meets the ANSI Z60.1 standard.
- 14. General Comment Pedestrian Connectivity. Pursuant to Section 7.03 Sidewalks of the Development Regulations, the Planning Board may require sidewalks for pedestrian traffic to provide a connection between the main entrances of business, housing or industrial establishments, parking areas and along public roadways. Further, the Planning Board may also require sidewalks from the road to the main building entrance or along the road frontage if there is a reasonable expectation pedestrian patrons, residents, neighbors, children, shoppers or employees would be traveling to or from the site.
- 15. The applicant will be required to file a voluntary lot consolidation form to merge both lots. This step would be required prior to Board signature of the plans set.


STAFF RECOMMENDATIONS:

The applicant should be prepared to address the comments raised by the Planning Board, Conservation Commission, Heritage Commission, Town Consultants, Staff, and public pertaining to the Site Plan. The Planning Board will need to determine if the proposed site development meets the purpose and intent of the overlay and potentially act on the waiver request. If the Board is satisfied with the information/responses from the applicant and finds that the remaining concerns can be addressed with staff, staff would recommend a conditional approval.

Aerial Photographs of Map 19, Lots 13 and 14



Street Level Photographs of Map 19, Lot 14

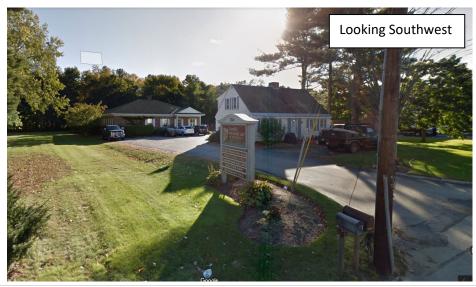



Street Level Photographs of Map 19, Lot 13






6

Site Plan Family Dental Care **PROFESSIONAL ASSOCIATION**


Connecting Dentistry & Your Health


ELM STREET, MILFORD, NEW HAMPSHIRE

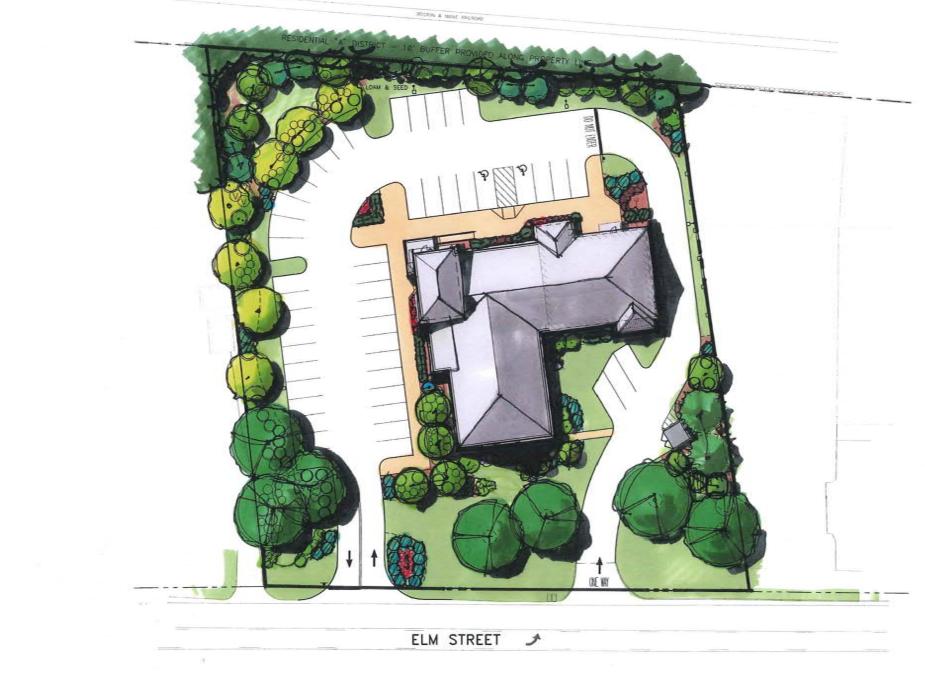

State and the second




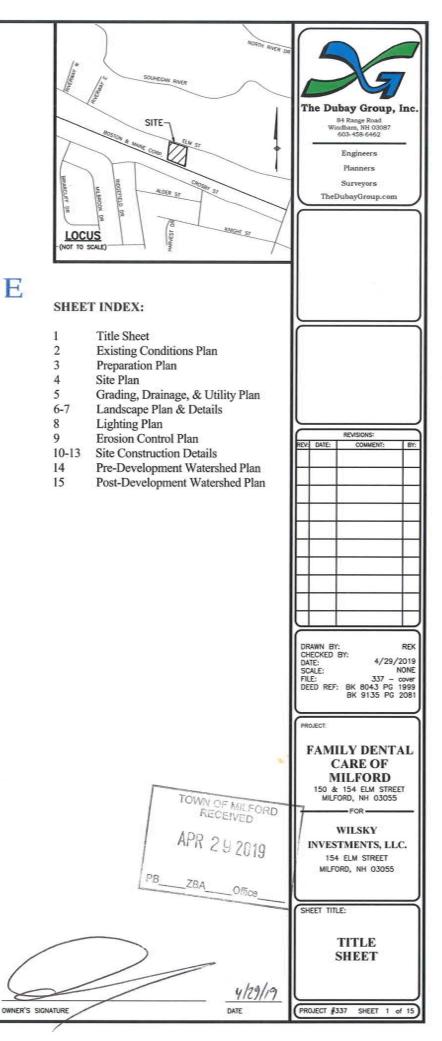

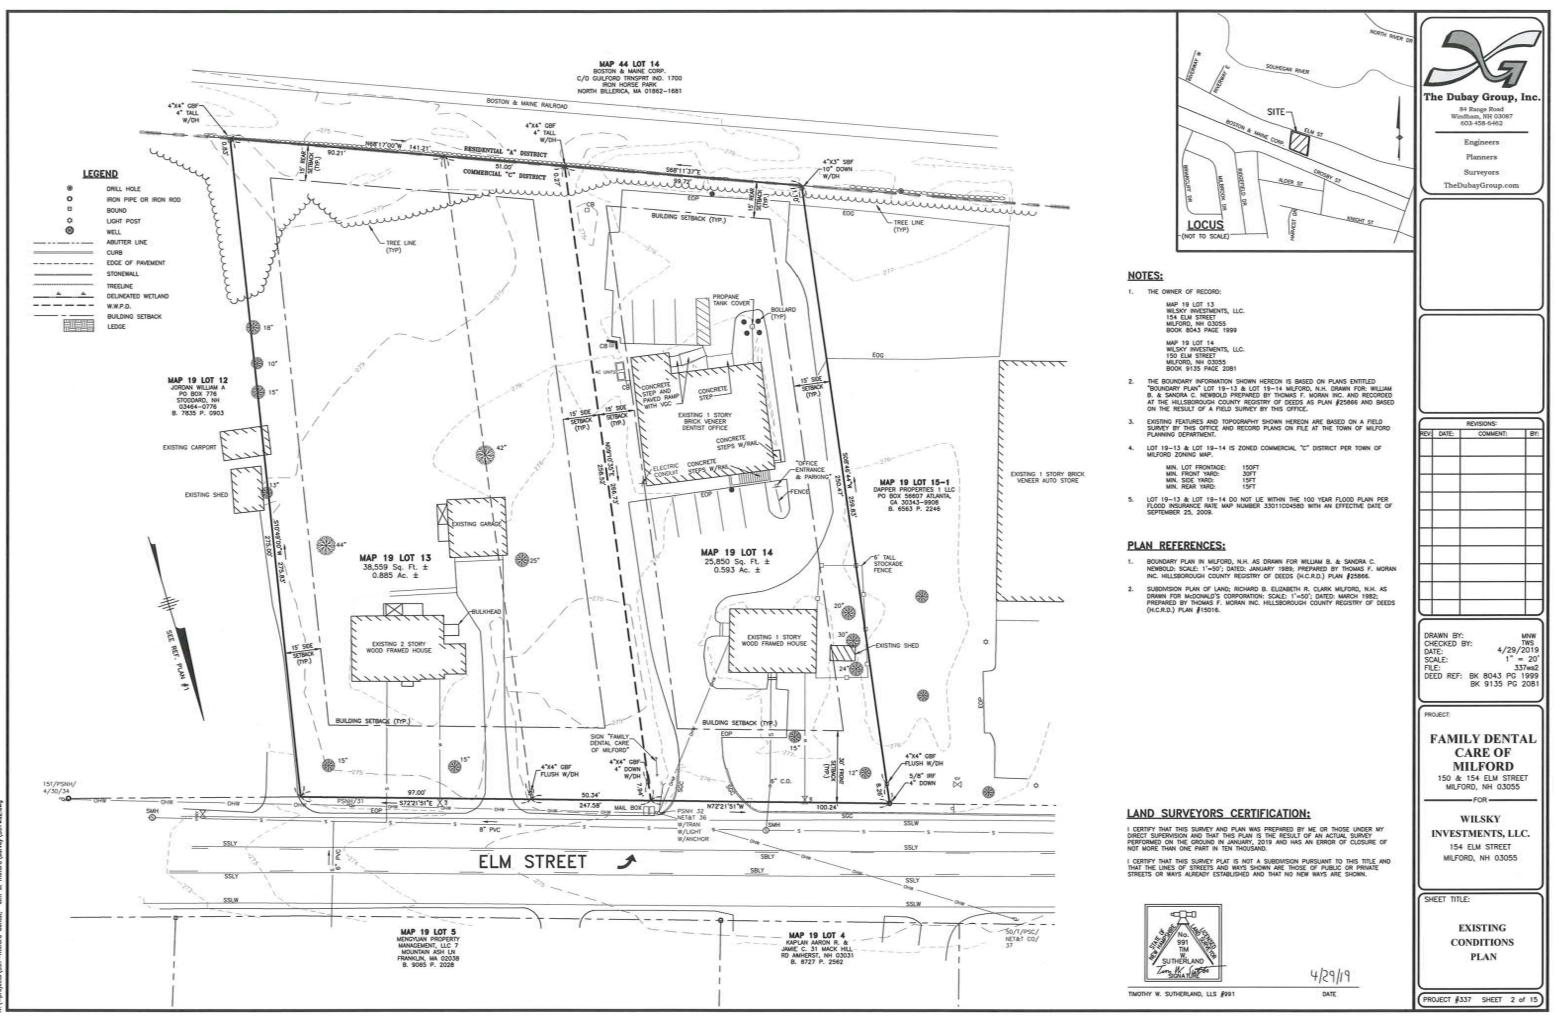

tils jajaab bestim www.v-



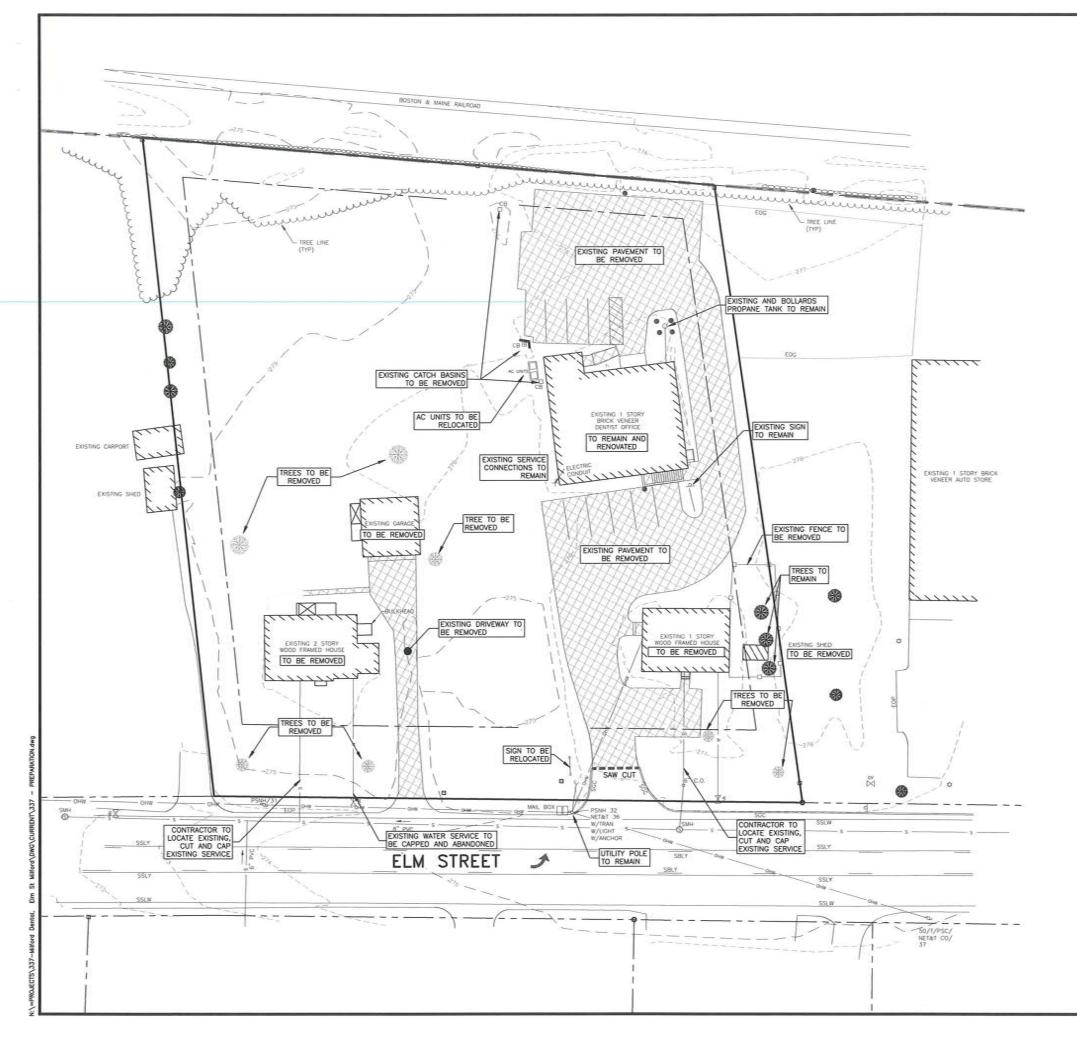


NO SOIL CONTAINING ANY LIVING OR VIABLE PORTION OF PLANTS ON THE NEW HAMPSHIRE PROHIBITED INVASIVE SPECIES LIST (AGR TABLE 3800) SHALL BE TRANSPORTED TO OR FROM CONSTRUCTION SITES WITHOUT NOTIFICATION AND APPROVAL FROM THE NEW HAMPSHIRE DEPT. OF AGRICULTURE PER IRSA 430:55.

2. ALL PAVEMENT PROPOSED TO BE REMOVED SHALL BE SAW CUT AT THE LIMITS OF REMOVAL

PRIOR TO CONSTRUCTION, CONTACT DIG-SAFE CENTER. TOLL FREE AT 811. NEW HAMPSHIRE STATE LAW REQUIRES NOTIFICATION AT LEAST 3 BUSINESS DAYS BEFORE DIGGING OPERATIONS START.

The Dubay Group, Inc. S ⁴ Range Road Windham, NH N0087 603-458-6462 Engineers Planners Surveyors TheDubayGroup.com					
Surveyors TheDubayGroup.com					
REVISIONS: REV DATE: COMMENT: BY:					
DRAWN BY: JHD CHECKED BY: 4/29/2019					
DATE: 4/29/2019 SCALE: 1=20' FILE: 337 - PREPARATION DEED REF: BK 8043 PC 1999 BK 9135 PG 2081 PROJECT: FAMILY DENTAL CARE OF MILFORD 150 & 154 ELM STREET MILFORD, NH 03055 -FOR					
WILSKY INVESTMENTS, LLC. 154 ELM STREET MILFORD, NH 03055 SHEET TITLE: PREPARATION					
PLAN (PROJECT #337 SHEET 3 of 15)					



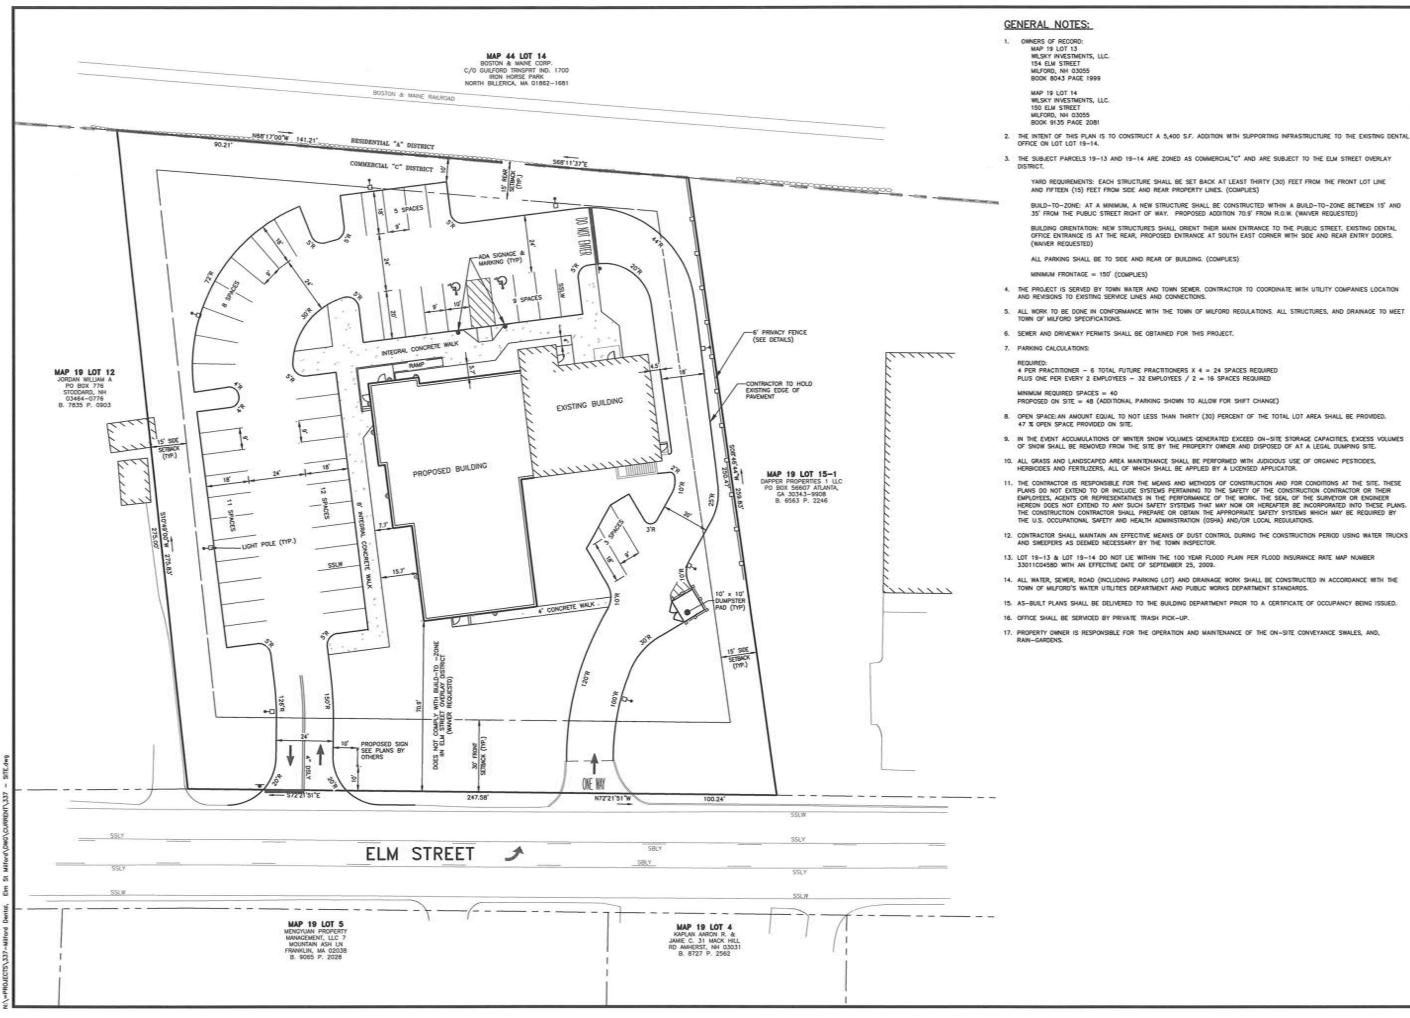

3. THE SUBJECT PARCELS 19-13 AND 19-14 ARE ZONED AS COMMERCIAL"C" AND ARE SUBJECT TO THE ELM STREET OVERLAY

YARD REQUIREMENTS: EACH STRUCTURE SHALL BE SET BACK AT LEAST THIRTY (30) FEET FROM THE FRONT LOT LINE AND FIFTEEN (15) FEET FROM SIDE AND REAR PROPERTY LINES. (COMPLIES)

BUILD-TO-ZONE: AT A MINIMUM, A NEW STRUCTURE SHALL BE CONSTRUCTED WITHIN A BUILD-TO-ZONE BETWEEN 15' AND 35' FROM THE PUBLIC STREET RIGHT OF WAY. PROPOSED ADDITION 70.9' FROM R.O.W. (WAIVER REQUESTED)

BUILDING ORIENTATION: NEW STRUCTURES SHALL ORIENT THER MAIN ENTRANCE TO THE PUBLIC STREET. EXISTING DENTAL OFFICE ENTRANCE IS AT THE REAR, PROPOSED ENTRANCE AT SOUTH EAST CORNER WITH SIDE AND REAR ENTRY DOORS.

4. THE PROJECT IS SERVED BY TOWN WATER AND TOWN SEWER. CONTRACTOR TO COORDINATE WITH UTILITY COMPANIES LOCATION

5. ALL WORK TO BE DONE IN CONFORMANCE WITH THE TOWN OF MILFORD REGULATIONS. ALL STRUCTURES, AND DRAINAGE TO MEET

8. OPEN SPACE: AN AMOUNT EQUAL TO NOT LESS THAN THIRTY (30) PERCENT OF THE TOTAL LOT AREA SHALL BE PROVIDED.

IN THE EVENT ACCUMULATIONS OF WINTER SNOW VOLUMES GENERATED EXCEED ON-SITE STORAGE CAPACITIES, EXCESS VOLUMES OF SNOW SHALL BE REMOVED FROM THE SITE BY THE PROPERTY OWNER AND DISPOSED OF AT A LEGAL DUMPING SITE.

11. THE CONTRACTOR IS RESPONSIBLE FOR THE MEANS AND METHODS OF CONSTRUCTION AND FOR CONDITIONS AT THE SITE. THESE THE CONTINUETOR IS REPORTED FOR THE WEAKS AND WEAKS AND WE SAFETY OF THE CONSTRUCTION AND CONTRACTOR OR THESE THESE PLANS. ON OR EXTEND OR WILL HESE STERING FOR THE SAFETY OF THE CONSTRUCTION CONTRACTOR OR THEIR EMPORES, AGENTS OR REPRESENTATIVES IN THE PERFORMANCE OF THE WORK. THE SEAL OF THE SURVEYOR OR ENGINEER HEREON DOES NOT EXTEND TO ANY SUCH SAFETY SYSTEMS WHICH MAY BE REQUIRED BY THE U.S. OCCUPATIONAL SAFETY AND HEALTH ADMINISTRATION (OSHA) AND/OR LOCAL REGULATIONS.


12. CONTRACTOR SHALL MAINTAIN AN EFFECTIVE MEANS OF DUST CONTROL DURING THE CONSTRUCTION PERIOD USING WATER TRUCKS AND SWEEPERS AS DEEMED NECESSARY BY THE TOWN INSPECTOR.

LOT 19-13 & LOT 19-14 DO NOT LIE WITHIN THE 100 YEAR FLOOD PLAIN PER FLOOD INSURANCE RATE MAP NUMBER 33011C0458D WITH AN EFFECTIVE DATE OF SEPTEMBER 25, 2009.

14. ALL WATER, SEWER, ROAD (INCLUDING PARKING LOT) AND DRAINAGE WORK SHALL BE CONSTRUCTED IN ACCORDANCE WITH THE TOWN OF MILFORD'S WATER UTILITES DEPARTMENT AND PUBLIC WORKS DEPARTMENT STANDARDS.

15. AS-BUILT PLANS SHALL BE DELIVERED TO THE BUILDING DEPARTMENT PRIOR TO A CERTIFICATE OF OCCUPANCY BEING ISSUED.

5-						
The Dubay Group, Inc.						
84 Range Road Windham, NH 03087 603-458-6462						
Engineers Planners						
Surveyors TheDubayGroup.com						
20 9 10 20 1 INCH = 20 FEET						
REVISIONS: REV: DATE: COMMENT: BY:						
DRAWN BY: JHD CHECKED BY: DGM DATE: 4/29/2019 SCALE: 1"=20" FILE: 337 - STE DEED REF: BK 8043 PG 1999 BK 9135 PG 2081						
PROJECT:						
FAMILY DENTAL CARE OF MILFORD 150 & 154 ELM STREET MILFORD, NH 03055						
WILSKY						
INVESTMENTS, LLC. 154 ELM STREET MILFORD, NH 03055						
SHEET TITLE:						
SITE PLAN						
PROJECT #337 SHEET 4 of 15						

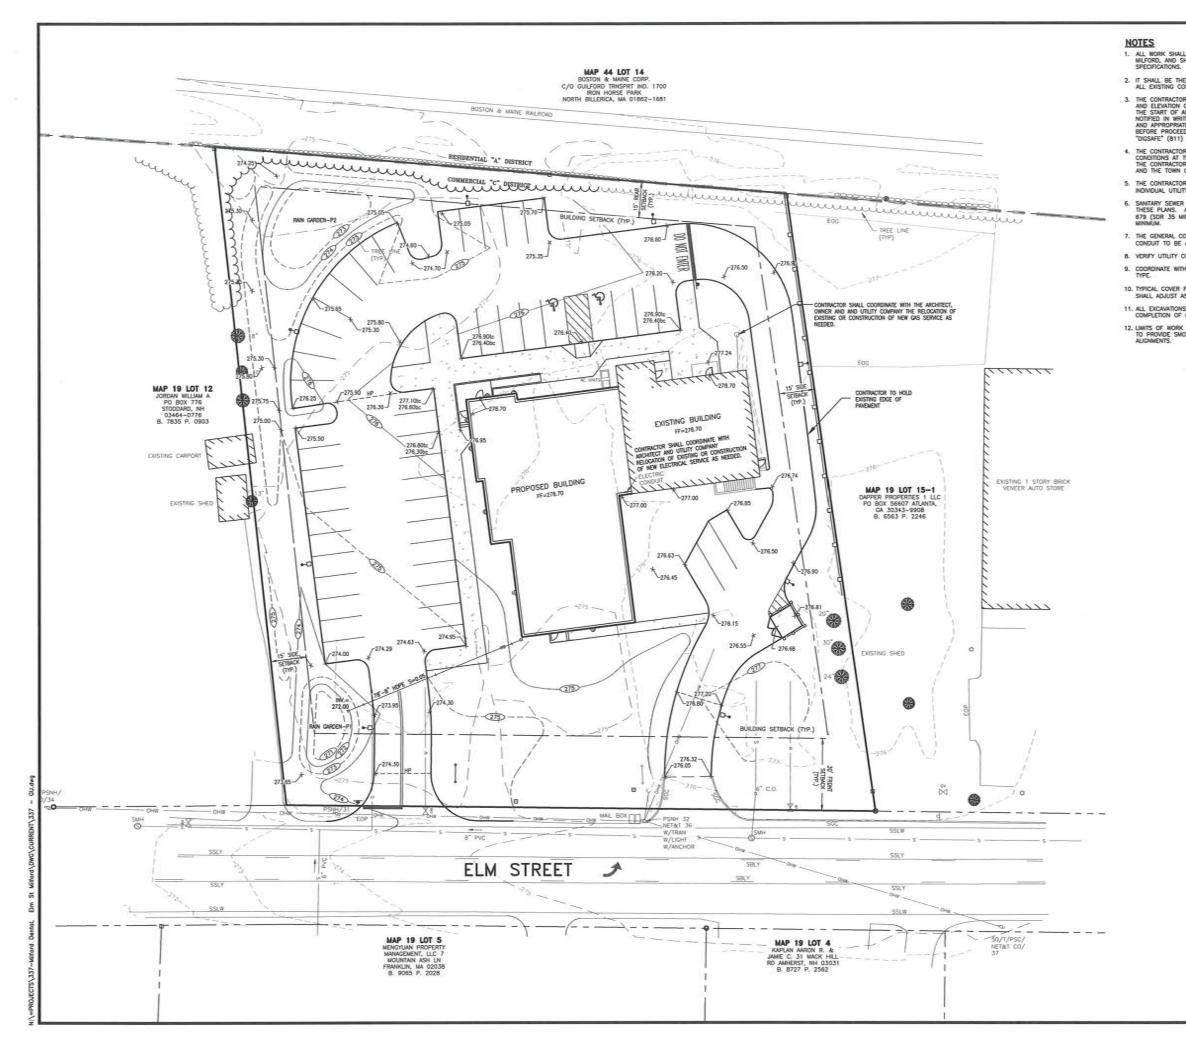

 ALL WORK SHALL CONFORM TO THE APPLICABLE REGULATIONS AND STANDARDS OF THE TOWN OF MILPORD, AND SHALL BE BUILT IN A WORKMANLIKE MANNER IN ACCORDANCE WITH THE PLANS AND SPECIFICATIONS.

 IT SHALL BE THE CONTRACTOR'S RESPONSIBILITY TO FAMILIARIZE THEMSELVES WITH THE SITE AND ALL EXISTING CONDITIONS SURROUNDING IT AND THEREON.

3. THE CONTRACTOR SHALL BE RESPONSIBLE FOR VERIFYING AND DETERMINING THE LOCATION, SIZE AND ELEVATION OF ALL DXISTING UTILITES, SHOIM OR NOT SHOWN ON THESE PLANS, PROR TO THE START OF ANY CONSTRUCTION. THE ENGINEER AND THE TOWN OF MILFORD SHALL BE NOTIFIED IN WRITING OF ANY UTILITIES FOUND INTERFERING WITH THE PROPOSED CONSTRUCTION AND APPROPRIATE REMEDIAL ACTION BE ARREED TO BY THE ENGINEER AND THE TOWN OF MILFORD BEFORE PROCEEDING WITH THE VERTICAL BE RESPONSIBLE TO CONTACT "DIGSAFE" (811) AT LEAST 72 HOURS BEFORE DIGGING.

4. THE CONTRACTOR IS RESPONSIBLE FOR THE MEANS AND METHODS OF CONSTRUCTION AND FOR THE CONDITIONS AT THE SITE. WRITTEN DIMENSIONS HAVE PRECEDENCE OVER SCALED DIMENSIONS. THE CONTRACTOR SHALL VERIFY ALL DIMENSIONS AND REPORT DISCREPANCIES TO THE ENGINEER AND THE TOWN OF MILFORD.

 THE CONTRACTOR SHALL COORDINATE WATERIALS AND INSTALLATION SPECIFICATIONS WITH THE INDIMIDUAL UTILITY AGENCIES/COMPANIES, AND ARRANGE FOR ALL INSPECTIONS.

6. SANTARY SEWER SHALL BE CONSTRUCTED TO THE STANDARDS AND SPECIFICATIONS AS SHOWN ON THESE PLANS. ALL SEWER MAINS AND FITTINGS SHALL BE PVC AND SHALL CONFORM TO ASTM F 679 (SDR 35 MINIMUM). HORIZONTAL SEPARATION BETWEEN WATER AND SEWER SHALL BE 10 FEET MINIMUM.

 THE GENERAL CONTRACTOR IS RESPONSIBLE FOR CONDUIT AND WIRING TO ALL SIGNS AND LIGHTS. CONDUIT TO BE A MINIMUM OF 24" BELOW FINISH GRADE.

8. VERIFY UTILITY CONNECTIONS TO BUILDING WITH ARCHITECTURAL DRAWINGS.


 COORDINATE WITH MECHANICAL AND PLUMBING PLANS FOR THE WATER SERVICE PIPE SIZE AND TYPE.

 TYPICAL COVER FOR ELECTRIC AND GAS SERVICES SHOWN SHALL BE 36" MINIMUM. CONTRACTOR SHALL ADJUST AS INCESSARY TO PROVIDE A MINIMUM OF 6" CLEARANCE BETWEEN ALL UTILITIES.
 ALL EXCAVATIONS SHALL BE THOROUCHLY SECURED ON A DAILY BASIS BY THE CONTRACTOR AT THE COMPLETION OF CONSTRUCTION OPERATIONS IN THE IMMEDIATE AREA.

 LIMITS OF WORK ARE SHOWN AS APPROXIMATE. THE CONTRACTOR SHALL COORDINATE ALL WORK TO PROVIDE SWOOTH TRANSITIONS. THIS INCLUDES GRADING, PAVEMENT, CURBING, SIDEWALKS AND ALIGNMENTS.

The Dubay Group, Inc. B& Rage Road Windham, NH 00807 603-458-6462 Engineers Planners Surveyors TheDubayGroup.com						
20 0 10 20 1 INCH - 20 FEET						
REVISIONS:						
REV: DATE: COMMENT: BY:						
DRAWN BY: JHD CHECKED BY: REK DATE: 4/29/2019 SCALE: 17=20' FILE: 337 - GU DEED REF: BK 8043 PG 1999 BK 9135 PG 2081						
FROJECT: FAMILY DENTAL CARE OF MILFORD 150 & 154 ELM STREET MILFORD, NH 03055 FOR						
FOR WILSKY INVESTMENTS, LLC. 154 ELM STREET MILFORD, NH 03055						
SHEET TITLE: GRADING, DRAINAGE, & UTILITY PLANS						



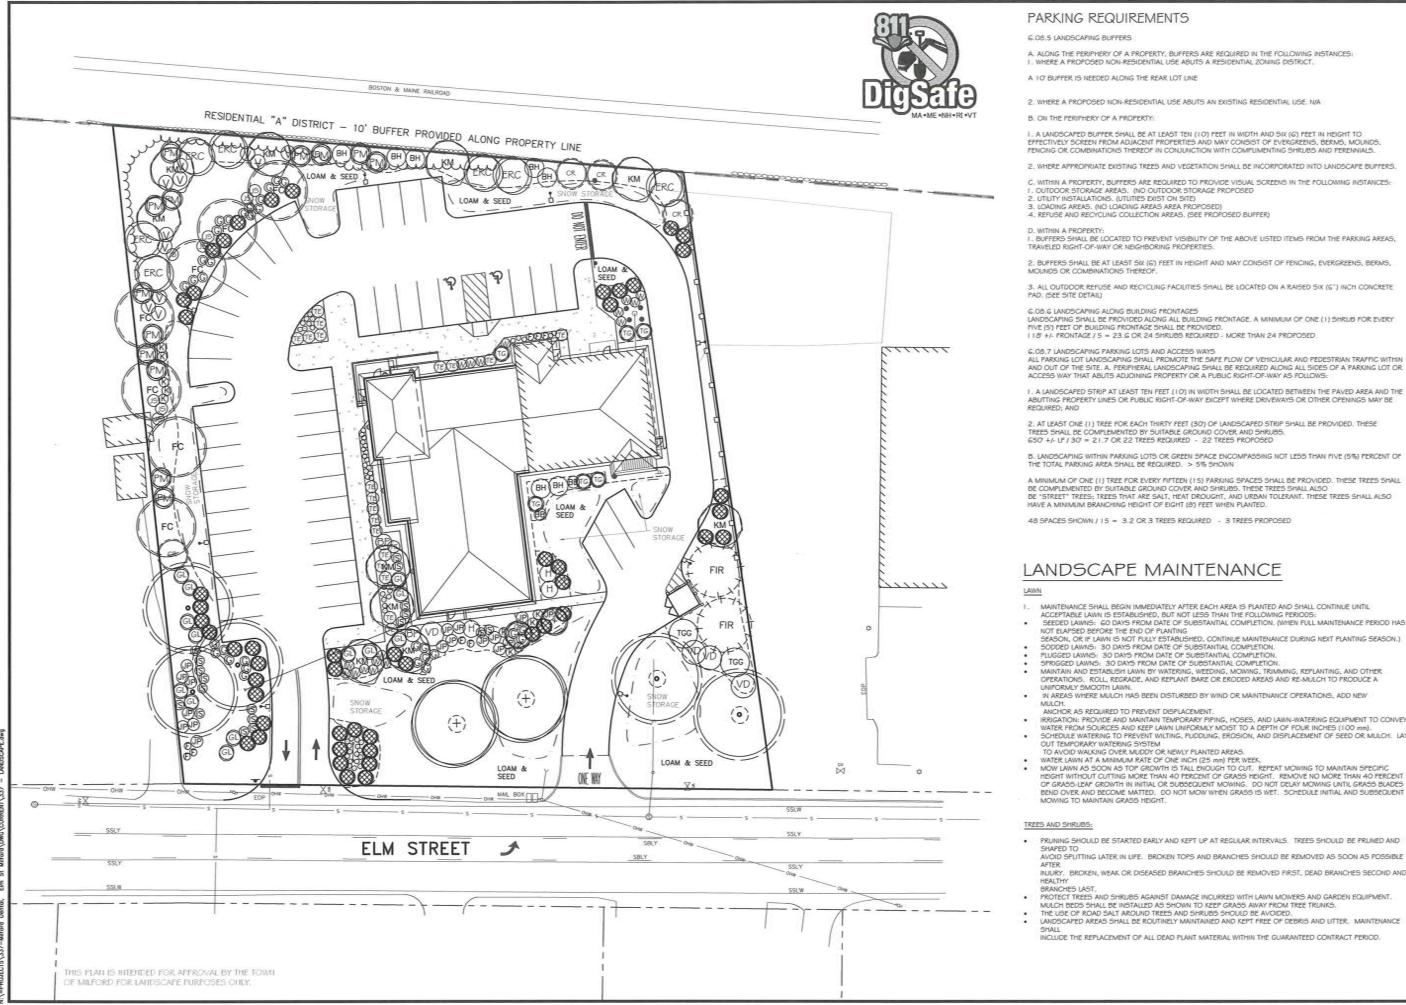

A. ALONG THE PERIPHERY OF A PROPERTY, BUFFERS ARE REQUIRED IN THE FOLLOWING INSTANCES: 1. WHERE A PROPOSED NON-RESIDENTIAL USE ABUTS A RESIDENTIAL ZONING DISTRICT.

I. A LANDSCAPED BUFFER SHALL BE AT LEAST TEN (10) FEET IN WIDTH AND SIX (G) FEET IN HEIGHT TO EFFECTIVELY SCREEN FROM ADJACENT PROPERTIES AND MAY CONSIST OF EVERGREENS, BERMS, MOUNDS, FENCING OR COMBINATIONS THEREOF IN CONJUNCTION WITH COMPUMENTING SHRUBS AND PERENNIALS.

2. WHERE APPROPRIATE EXISTING TREES AND VEGETATION SHALL BE INCORPORATED INTO LANDSCAPE BUFFERS.

C. WITHIN A PROPERTY, BUFFERS ARE REQUIRED TO PROVIDE VISUAL SCREENS IN THE FOLLOWING INSTANCES:

2. BUFFERS SHALL BE AT LEAST SIX (G) FEET IN HEIGHT AND MAY CONSIST OF FENCING, EVERGREENS, BERMS,

3. ALL OUTDOOR REFUSE AND RECYCLING FACILITIES SHALL BE LOCATED ON A RAISED SIX (6") INCH CONCRETE

G.OB.G LANDSCAPING ALONG BUILDING FRONTAGES LANDSCAPING SHALL BE PROVIDED ALONG ALL BUILDING FRONTAGE. A MINIMUM OF ONE (1) SHRUB FOR EVERY FIVE (5) FEET OF BUILDING FRONTAGE SHALL BE PROVIDED.

ALL PARKING LOT LANDSCAPING SHALL PROMOTE THE SAFE FLOW OF VEHICULAR AND PEDESTRIAN TRAFFIC WITHIN AND OUT OF THE SITE. A, PERIPHERAL LANDSCAPING SHALL BE REQUIRED ALONG ALL SIDES OF A PARKING LOT OR ACCESS WAY THAT ABUTS ADJOINING PROPERTY OR A PUBLIC RIGHT-OF-WAY AS FOLLOWS:

1. A LANDSCAPED STRIP AT LEAST TEN FEET (10) IN WIDTH SHALL BE LOCATED BETWEEN THE PAVED AREA AND THE ABUITING PROPERTY LINES OR PUBLIC RIGHT-OF-WAY EXCEPT WHERE DRIVEWAYS OR OTHER OPENINGS MAY BE

2. AT LEAST ONE (1) TREE FOR EACH THIRTY FEET (30) OF LANDSCAPED STRIP SHALL BE PROVIDED. THESE TREES SHALL BE COMPLEMENTED BY SUITABLE GROUND COVER AND SHRUBS.

B. LANDSCAPING WITHIN PARKING LOTS OR GREEN SPACE ENCOMPASSING NOT LESS THAN FIVE (5%) PERCENT OF THE TOTAL PARKING AREA SHALL BE REQUIRED. > 5% SHOWN

A MINIMUM OF ONE (1) TREE FOR EVERY FIFTEEN (15) PARKING SPACES SHALL BE PROVIDED. THESE TREES SHALL BE COMPLEMENTED BY SUITABLE GROUND COVER AND SHRUBS. THESE TREES SHALL ALSO BE "STREET" TREES; TREES THAT ARE SALT, HEAT DROUGHT, AND URBAN TOLERANT. THESE TREES SHALL ALSO

SEEDED LAWNS: GO DAYS FROM DATE OF SUBSTANTIAL COMPLETION, (WHEN FULL MAINTENANCE PERIOD HAS

NOT ELAPSED BEFORE THE END OF FLUTING SEASON, OR IF LAWN IS NOT FULLY ESTABLISHED, CONTINUE MAINTENANCE DURING NEXT PLANTING SEASON.) SODDED LAWNS: 30 DAYS FROM DATE OF SUBSTANTIAL COMPLETION.

OPERATIONS. ROLL, REGRADE, AND REPLANT BARE OR ERODED AREAS AND RE-MULCH TO PRODUCE A

ANDLOFT. ANCHOR AS REQUIRED TO PREVENT DISPLACEMENT. IRRIGATION: PROVIDE AND MAINTAIN TEMPORARY PIPING, HOSES, AND LAWN-WATERING EQUIPMENT TO CONVEY WATER FROM SOURCES AND SEEP LAWN UNIFORMLY MOIST TO A DEPTH OF FOUR INCHES (100 mm). SCHEDULE WATERING TO PREVENT WILTING, PUDDLING, EROSION, AND DISPLACEMENT OF SEED OR MULCH. LAY

WATER LAWN AT A MINIMUM RATE OF ONE INCH 15 MILET BALLO. WATER LAWN AT A MINIMUM RATE OF ONE INCH [25 mm] PER WEEK. MOW LAWN AS SOON AS TOP GROWTH IS TALL ENOUGH TO CUT. REPEAT MOWING TO MAINTAIN SPECIFIC HEIGHT WITHOUT CUTTING MORE THAN 40 PERCENT OF GRASS HEIGHT. REMOVE NO MORE THAN 40 PERCENT OF GRASS-LEAF GROWTH IN INITIAL OR SUBSEQUENT MOWING. DO NOT DELAY MOWING UNTIL GRASS BLADES BEND OVER AND BECOME MATTED. DO NOT MOW WHEN GRASS IS WET. SCHEDULE INITIAL AND SUBSEQUENT

· PRUNING SHOULD BE STARTED EARLY AND KEPT UP AT REGULAR INTERVALS. TREES SHOULD BE PRUNED AND

AVOID SPLITTING LATER IN LIFE. BROKEN TOPS AND BRANCHES SHOULD BE REMOVED AS SOON AS POSSIBLE

INJURY. BROKEN, WEAK OR DISEASED BRANCHES SHOULD BE REMOVED FIRST, DEAD BRANCHES SECOND AND


PROTECT TREES AND SHRUBS AGAINST DAMAGE INCURRED WITH LAWN MOWERS AND GARDEN EQUIPMENT.

INCLUDE THE REPLACEMENT OF ALL DEAD PLANT MATERIAL WITHIN THE GUARANTEED CONTRACT PERIOD.


The Dubay Group, Inc. At Range Road Windham, NH 00087 603-458-6462 Engineers Planners Surveyors TheDubayGroup.com		
REVISIONS:		
REV: DATE: COMMENT: BY:		
DRAWN BY: REK CHECKED BY: 4/29/2019 DATE: 1"=20" FILE: 337 – LANDSCAFE DEED REF: BK 8043 PG 1999 BK 9135 PG 2081		
PROJECT:		
FAMILY DENTAL CARE OF MILFORD 150 & 154 ELM STREET MILFORD, NH 03055		
FOR WILSKY INVESTMENTS, LLC. 154 ELM STREET MILFORD, NH 03055		
SHEET TITLE:		
LANDSCAPE PLAN		
PROJECT #337 SHEET 6 of 15		
THOUSED POUL SHEET 6 of 15		




SLOPE PLANTING DETAIL

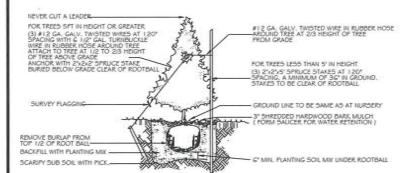

EVERGREEN PLANTING DETAIL

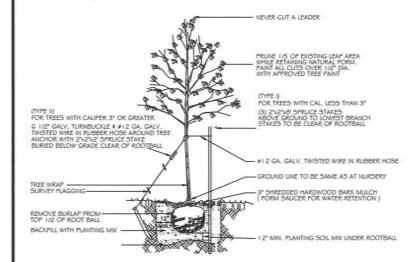

DECIDUOUS TREE PLANTING DETAIL NIS

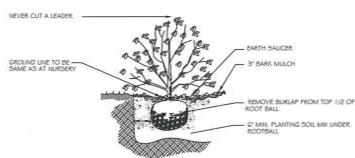

SHRUB PLANTING DETAIL

LANDSCAPE NOTES:

I. PRIOR TO CONSTRUCTION THE CONTRACTOR IS RESPONSIBLE FOR VERIFICATION OF ALL EXISTING AND NEWLY INSTALLED UTILITIES AND SHALL NOTIFY THE OWNERS REPRESENTATIVE OF ANY CONFLICTS.

2. LANDSCAPING SHOWN ON THIS PLAN HAS BEEN DESIGNED TO COMPLY WITH THE TOWN OF MILFORD LANDSCAPE REGULATIONS.

3. WHEREVER POSSIBLE EXISTING TREES SHALL BE PRESERVED AND PROTECTED DURING CONSTRUCTION AS

4. THE PROPOSED DECIDIOUS TREES SHALL BE A MIN. 2, 5%3, 5% CALIPER WITH A MINIMUM HEIGHT OF 1,2% EVERGREEN TREES A MINIMUM OF G' HIGH AND SHRUBS 2' AT TIME OF PLANTING

5. ALL DISTURBED AREAS SHALL BE LOAMED AND SEEDED WITH A MINIMUM OF G" SUITABLE LOAM, DICEPT UNDER THE MULCH BEDS. SLOPES GREATER THAN 3:1 SHALL BE PROTECTED WITH AN EROSION CONTROL BLANKET. (SEE PLANS BY ENGINEER)

6. PLANTS SHALL NOT BE INSTALLED UNTIL ALL GRADING AND CONSTRUCTION HAS BEEN COMPLETED WITHIN THE IMMEDIATE AREA OF THE PLANTING

7. ALL TREES SHALL BE BALLED AND BUR LAPPED UNLESS OTHERWISE NOTED.

8. ANY PROPOSED PLANT MATERIAL SUBSTITUTIONS SHALL BE APPROVED BY THE OWNER'S REPRESENTATIVE, THE TOWN OF MILFORD STAFF AND THE LANDSCAPE ARCHITECT.

9. WHERE APPLICABLE THE CONTRACTOR SHALL HAVE ALL FALL TRANSPLANTING HAZARD PLANTS DUG IN THE SPRING.THE CONTRACTOR SHALL BE RESPONSIBLE FOR PLANTING AT CORRECT GRADES AND ALIGNMENT. LAYOUT TO BE APPROVED BY OWNERS REPRESENTATIVE PRIOR TO INSTALLATION.

10. PLANTS SHALL BE TYPICAL OF THEIR SPECIES AND VARIETY; HAVE NORMAL GROWTH HABITS; WELL DEVELOPED BRANCHES, DENSELY FOLIATED, VIGOROUS ROOT SYSTEMS AND BE FREE FROM DEFECTS AND INJURIES.

11. CONTRACTOR SHALL REPORT ANY SOIL OR DRAINAGE CONDITIONS CONSIDERED DETRIMENTAL TO THE GROWTH OF PLANT MATERIAL.

12. ALL PLANT MATERIAL SHALL BE GUARANTEED BY THE CONTRACTOR TO BE IN VIGOROUS GROWING CONDITION. PROVISION SHALL BE MADE FOR A GROWTH GUARANTEE OF AT LEAST ONE YEAR FROM THE DATE OF ACCEPTANCE FOR TREES AND SHRUBS. REPLACEMENTS SHALL BE MADE AT THE BEGINNING OF THE FIRST. SUCCEEDING PLANTING SEASON. ALL REPLACEMENTS SHALL HAVE A GUARANTEE EQUAL TO THAT STATED

13. INSOFAR AS IT IS PRACTICABLE, PLANT MATERIAL SHALL BE PLANTED ON THE DAY OF DELIVERY. IN THE EVENT THIS IS NOT POSSIBLE, THE CONTRACTOR SHALL PROTECT STOCK NOT PLANTED. PLANTS SHALL NOT REMAIN UNPLANTED FOR LONGER THAN A THREE DAY PERIOD AFTER DELIVERY. ANY PLANTS NOT INSTALLED DURING THIS PERIOD WILL BE REJECTED.

14. QUALITY AND SIZE OF PLANTS, SPREAD OF ROOTS, AND SIZE OF BALLS SHALL BE IN ACCORDANCE WITH ANSI 2GO (REV. 1996) "AMERICAN STANDARD FOR NURSERY STOCK" AS PUBLISHED BY THE AMERICAN ASSOCIATION OF NURSERYMEN, INC.

15, ALL PLANTS SHALL BE PLANTED IN AMENDED TOP SOIL THAT IS THOROUGHLY WATERED AND TAMPED AS BACK FILLING PROGRESSES, PLANTING MIX TO BE AS SHOWN ON PLANTING DETAILS. LARGE PLANTING AREAS TO INCORPORATE FERTILIZER AND SOIL CONDITIONERS AS STATED IN PLANTING SPECIFICATIONS.

I.G. PLANTS SHALL NOT BE BOUND WITH WIRE OR ROPE AT ANY TIME SO AS TO DAMAGE THE BARK OR BREAK BRANCHES. PLANTS SHALL BE HANDLED FROM THE BOTTOM OF THE BALL ONLY.

17. PLANTING OPERATIONS SHALL BE PERFORMED DURING PERIODS WITHIN THE PLANTING SEASON WHEN WEATHER AND SOIL CONDITIONS ARE SUITABLE AND IN ACCORDANCE WITH ACCEPTED LOCAL PRACTICE. PLANTS SHALL NOT BE INSTALLED IN TOPSOIL THAT IS IN A MUDDY OR FROZEN CONDITION. ALL PLANT MATERIAL SHALL BE SPRAYED WITH WILT-PRUP OR EQUAL AS PER MANUFACTURERS INSTRUCTIONS.

18. NO PLANT, EXCEPT GROUND COVERS/PERENNIALS, SHALL BE PLANTED LESS THAN TWO FEET FROM EXISTING STRUCTURES AND SIDEWALKS.

19. SET ALL PLANTS PLUMB AND STRAIGHT. SET AT SUCH LEVEL THAT, A NORMAL OR NATURAL RELATIONSHIP TO THE CROWN OF THE PLANT WITH THE GROUND SURFACE WILL BE ESTABLISHED. LOCATE PLANT IN THE CENTER OF THE PIT.

20 AU PRISTING TREES TO REMAIN SHALL BE PRIMED TO REMOVE ANY DAMAGED BRANCHES AS A RESULT. 20. ALL DISTRUCTION OPERATIONS. ALL DISTING TREES SHALL BE FERTILIZED WITH A REGULAR GARDEN PERTILIZER (5-10-5) UPON COMPLETION OF WORK. THE ENTIRE LIMB OF ANY DAMAGED BRANCH SHALL BE. CUT OFF AT THE TRUNK. CONTRACTOR TO ENSURE THAT CUTS ARE SMOOTH AND STRAIGHT. ANY EXPOSED CONTRACTOR IS TO PROTECT ALL EXISTING TREES TO REMAIN BY CRECTING TREE PROTECTION FENCE AT THE DRIP LINE. THIS WILL ENSURE NO COMPACTION OF THE ROOT MASS.

21. ALL PLANTING BEDS SHALL BE MULCHED WITH 3" LAYER OF DOUBLE SHREDDED HARDWOOD BARK MULCH. MUICH SHALL NOT COVER ROOT FLARE OF TREES.

22. THE PURPOSE OF THIS PLAN IS FOR LANDSCAPE PURPOSES ONLY.

23 THE OWNER AND THEIR REPRESENTATIVE SHALL BE RESPONSIBLE FOR PROVIDING PROTECTING AND MAINTAINING ALL LANDSCAPING IN HEALTHY AND GROWING CONDITION, AND REPLACING IT WHEN NECESSARY TO INSURE CONTINUOUS CONFORMANCE WITH THESE GUIDELINES. ANY LANDSCAPE ELEMENT THAT DIES, OR IS OTHERWISE REMOVED, SHALL BE PROMPTLY REPLACED WITH THE SAME, IF NOT SIMILAR 10, HEIGHT OR TEXTURE ELEMENT AS ORIGINALLY INTENDED. IN ADDITION, LANDSCAPED AREAS SHALL BE KEPT FREE OF ALL DEBRIS, RUBBISH, WEEDS AND OVERGROWN TURF GRASS. IF THE OWNERSHIP OF A SITE IS CONVEYED TO A NEW PROPERTY OWNER. THE NEW OWNER SHALL BE RESPONSIBLE FOR MAINTAINING ALL LANDSCAPING IN ACCORDANCE WITH THE APPROVED FINAL LANDSCAPING PLAN

24. ALL NEW PLANTING AREAS, LAWN AND SOD SHALL BE PROVIDED WITH A DRIP IRRIGATION SYSTEM.

25. INVASIVE SPECIES AND/OR TOXIC PLANTS SUCH AS POISON IVY, POISON OAK, POISON SUMAC AND/OR GIANT HOG WEED SHALL BE MANAGED ACCORDING TO ACCEPTED HORTICULTURAL TECHNIQUES AND PROVISIONS CREATED BY THE STATE OF NH AND THE STANDARDS OF ANSI A300.7.

FC

KM

0

+

FIR

ERC

TOG

0

0

0

0

Ø

0

0

0

(BH)

0

CR

Θ

VD

 \otimes

8


0

0


0

Ð


LAN	NDSCA	APE LEGEND				
	5	ACER SACCHARUM 'COMMEMORATION' / COMMEMORATION SUGAR MAPLE	2.5" CAL 8#8	40-60	30-40	29
Ď	2	GLEDITSIA T.I. HALKA' / HALKA HONEYLOCUST	2.5" CAL. B#B	30-40	30-40	The Dubay Group, Inc. 84 Range Road Windham, NH 03087 603-458-6462
)	7	PRUNUS SUBHIRTELLA. YUTUMNALIS' / AUTUMN FLOWERING CHERRY	2.5* CAL, 848	20'-30'	20'-30'	Engineers Planners Surveyors
)	10	ACER RUBRUM KARFICK / KARFICK RED MAPLE	2.5" CAL. B#B	40-60	15-20	TheDubayGroup.com
)	2	QUERCUS PALUSTRIS 'GREEN PILLAR' / GREEN PILLAR PIN OAK	2.5" CAL 848	40-60	10-15	
	2	ABIES FRAGERI / FRAGER FIR	G' HT. B¢B	30'-40'	20'-30'	
)	7	JUNIPERUS VIRGINIANA / EASTERN RED CEDAR	G' HT. B#B	30-40	15-20	
)	2	THUJA OCCIDENTALLIS NIGRA / DARK AMERICAN ABORVITAE	G'HT. B¢B	30'-40'	15'-20'	
)	2	JUNIPERUS CHINENSIS 'BLUE POINT' / BLUE POINT JUNIPER	4' HT. B≰B	8'+1Q'	8-10	
Č.	13	PINUS MUGO MUGO - COMPACT MUGO PINE	3° HT. B¢B	6-81	8-10	
	13	JUNIPERUS CHINENSIS WRINGTRONG AUREA' / OLD GOLD JUNIPER	30° 848	3'-4'	6-8	
	50	JUNIPERUS VIRGINIANA ' GREY OWL' / GREY OWL JUNIPER	30° B4B	2'-3'	6-8	
	17	J. CHINENSIS ' PRITZERIANA COMPACTA' / COMPACT PRITZER JUNIPER	30° B48	2"-3"	5'-6'	REVISIONS:
	ð	JUNIPERUS CHINENSIS 'SEAGREEN / SEAGREEN JUNIPER	30° B4B	5%6	4.5	REV: DATE: COMMENT: BY:
	6	TAXUS MEDIA 'GREENWAVE' / GREENWAVE SPREADING YEW	30' B4B	3'-4'	6-8	3
	21	TAXUS MEDIA 'EVER-LOW' / EVER-LOW YEW	5 GAL	2'	556	6
	2	PIERIS BROWERS BEAUTY / BROWERS BEAUTY ANDROMEDA	36° B4B	4'-5'	4'-5'	
	7	ILEX MESERVAE 'BLUE PRINCE' / BLUE PRINCE HOLLY	36'	6'-8'	8-10	
)	4	CORNUS RACEMOSA / GREY DOGWOOD	4	10-15	10-15	
	3	HYDRANGEA PANICULATA 'LITTLE QUICK FIRE'	4' HT. B#B	8-10	8-10	
í.	4	VIBURNUM DENTANUM / ARROWWOOD VIBURNUM	4' HT. B\$B	8-10	8-10	
	11	VACCINIUM CORYMBOSUM / HIGH BUSH BLUEBERRY	4' HT. 848	8'-10'	8-10	
	10	CARYOPTERIS CLANDONENSIS DARK KNIGHT / DARK KNIGHT SPIREA	5 GAL	3'-4'	4'-5'	
	18	ILEX VERTICILLATA RED SPRITE / RED SPRITE WINTERBERRY	3 GAL	3'-4'	3'-4'	
	32		3 GAL	18"-24"	ଟ-୫	DRAWN BY: REK
	17		3 GAL	31	3-4'	CHECKED BY: DATE: 4/29/2019
	8		2 GAL	2-3	2-3'	SCALE: FILE: 337 - LANDSCAPE
	52	HEMEROCALUS 'STEPHANIE RETURNS' / DAYLILY, STEPHANIE RETURNS	2 GAL	2"	2'	DEED REF: BK 8043 PG 1999 BK 9135 PG 2081
						PROJECT: FAMILY DENTAL CARE OF MILFORD 150 & 154 ELM STREET MILFORD, NH 03055 WILSKY INVESTMENTS, LLC. 154 ELM STREET MILFORD, NH 03055
		B11 DIGSa	APPRO MILFOI PURPO	LAN IS INTENDE WAL BY THE TO RD FOR LANDSO ISES ONLY.	WN OF	SHEET TITLE: LANDSCAPE DETAILS

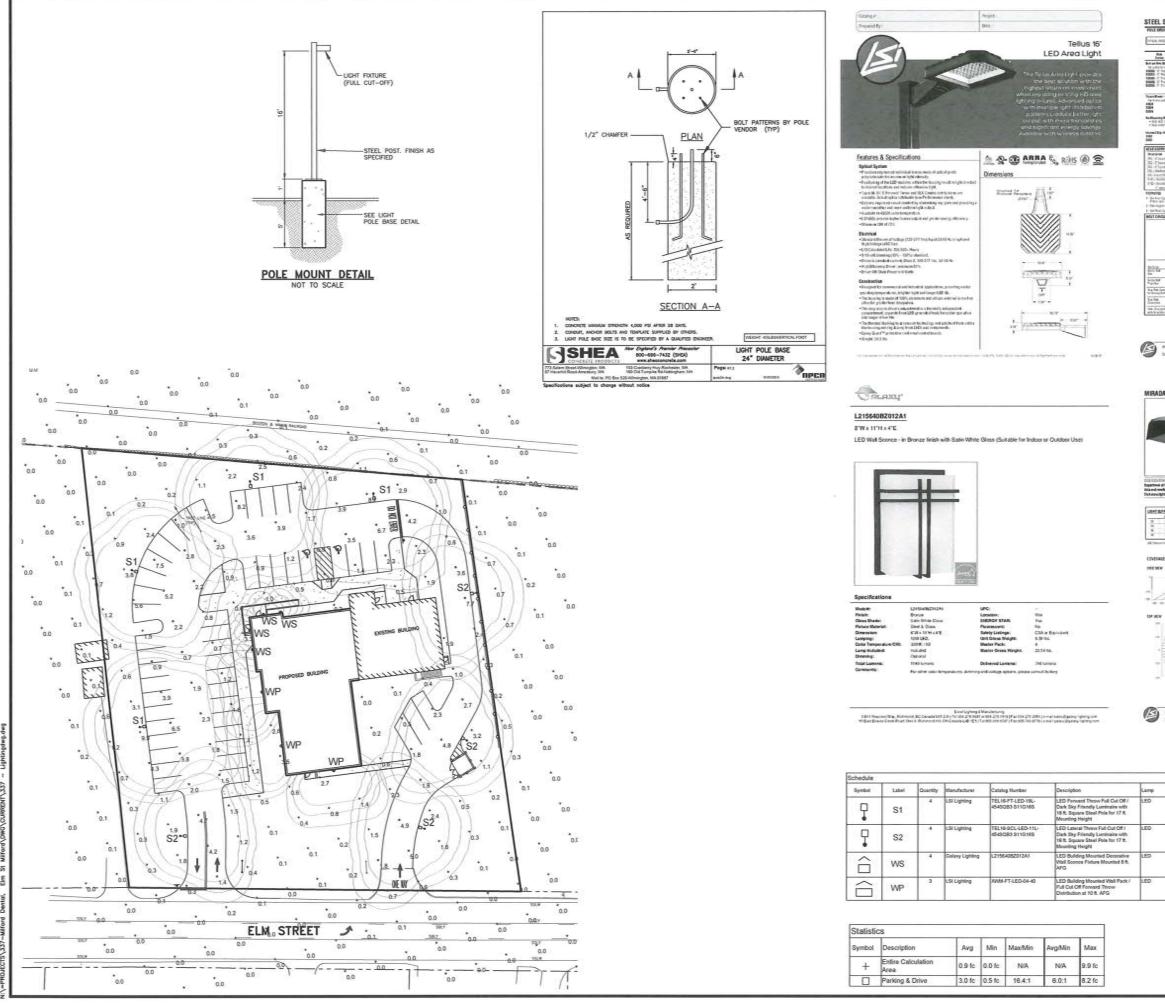

PML 55085	\$07G	24 S PLP	SF DGP	1	
	Kerte	- Ma		- to-	Spine .
Anciela verter pati de catiles, de loguiges, de loguiges, de loguiges, de loguiges, de loguides, de loguides, de loguides,	305-251 300-753	04 11 5-3544-7514 De 11 207-5146 11 207-5146 12 207-5146 12 107-514 13 107-5146 14 107-5146	27500 254 255 255 255 255 255 255 255 255 255	Figs 27 http://www.com/ http://wwww.com/ http://wwwwwwwwwww.com/ http://wwwwwwwwwwwwwwwwwwwwwwwwwwwwwwwwww	- Contrand Barton Bell - Singa Asan ² - Sanah Nod ² 2 -
virrentita gain virrentita gain	1	2) UP-Gat 2) 207-Gat 3) 31 31 31 31 31 31 31 31 31 31 31 31 31	ois21(f12)	Randood SF waited parts Of a The heapy of the part of service specified	
an da Si Si da	Darma	a Steria generation			
land articleted Sec Sec Sec Sectors		A di teshiri Teshiri Teshiri Teshiri A diska basar 2 Nical Alaka b	Taus 1920 Cersultus Saug Sadden nuclei Saug Sadden nuclei Saug Saug Salar Sala Saug Salar Sang Sang Sang Sang Sang Sang		10- factor 1720 1700 1700 1700 1700 1700 1700 1700
eter 2 Tubue Date 1 Tubue Date 1 Final Date Notice 1 Final Date Notice		lçin lə+25-inul r		Tory W Longs of 2014 and repaired address of the set	Martin Andreads 1955 Million Street
		(
I Stre Tollers Durg Striff (Data Stre Data Str Data	d Telef Telef Strong St	1 4 47 2200.2700 12 2200.28604 220 12200.	Litere Statere notifiere Tares Iter There There		
STAL District Stat State Over Security Over State	and: softened bit soften to he he he		ut cras or 20vil OH		
(keg			Fahara Toos		. 85.5
itani ji					010000 C
-111		unter - Sector - Strong - Sector - Sect	CARDEN OF SECURITY Of the Automatic Advances of the	tergenture 7000 v	12010-01
73 Terrafia depend conference de second conference de second de se	atina puoluka kuk kup Andra Mayann kup atingan kup Andra Kup Andra Kup Andra Kup Andra	 Bits - Anter and State of State Sta	In the second se	An experiment of the second se	Notes and the second se
C23 grie reaf at expression approved a to tage at contrast of the tage at contrast of	atina puoluka kuk kup Andra Mayann kup atingan kup Andra Kup Andra Kup Andra Kup Andra	 and a Strainter and Strainter a	All the second s	Research 2014 To the second se	Robert and Roberts Chronic throppedia stage production and production and
CCI grift to section of the Section constrained of the Section constrained of the Section constrained of the Section constrained of the Section of the Section of the Section Constrained of the Section of the Secti	atina puoluka kuk kup Andra Mayann kup atingan kup Andra Kup Andra Kup Andra Kup Andra	 and a Strategy and a St	All the second s	Research 2014 To the second se	Norma Auf Market Chronic Torpeting and and profile a
	atina puoluka kuk kup Andra Mayann kup atingan kup Andra Kup Andra Kup Andra Kup Andra	 Bits - Links and State of State Sta	All the second s	Research 2014 To the second se	Robert and Roberts Chronic throppedia stage production and production and
ECE gris realist aprend continue eff in Light int care for get in Light int care for get in Light int care in Light int	atina puoluka kuk kup Andra Mayann kup atingan kup Andra Kup Andra Kup Andra Kup Andra	 Bits - Links and State of State Sta	All the second s	An and a second	Holman All Ma Holman Chronie Horpstein H
		 Belle - Andre - H Steller Belle -	Clampes Per	Expertence - 200 terms provide mode of a term provide mode of a term provide mode of a term provide mode of a provide mode of a provide mode of a term provide of a term provid	Robert and Hermitian Characterian Streem Str
		 Bits - Links and State of State Sta	All De Arbeits and de Arbeits All De Arbeits and an anti-anti-anti-anti-anti- anti-anti-anti-anti-anti-anti- anti-anti-anti-anti-anti- anti-anti-anti-anti-anti- anti-anti-anti-anti-anti- anti-anti-anti-anti-anti- anti-anti-anti-anti-anti- anti-anti-anti-anti- anti-anti-anti-anti-anti- anti-anti-anti- anti-anti-anti-anti- anti-anti-anti- anti-anti-anti-anti- anti-anti-anti-anti- anti-anti-anti-anti- anti-anti-anti-anti- anti-anti-anti-anti- anti-anti-anti-anti- anti-anti-anti-anti- anti-anti-anti-anti- anti-anti-anti-anti- anti-anti-anti-anti- anti-anti-anti-anti- anti-anti-anti-anti- anti-anti-anti-anti- anti-anti-anti-anti- anti-anti-anti-anti- anti-anti-anti-anti- anti-anti-anti-anti-anti- anti-anti-anti-anti- anti-anti-anti-anti- anti-anti-anti- anti-anti-anti-anti- anti-anti-anti-anti- anti-anti-anti-anti- anti-anti-anti-anti- anti-anti-anti-anti- anti-anti-anti-anti- anti-anti-anti-anti- anti-anti-anti-anti-anti- anti-anti-anti-anti-anti- anti-anti-anti-anti-anti- anti-anti-anti-anti-anti- anti-anti-anti-anti-anti- anti-anti-anti-anti-anti- anti-anti-anti-anti-anti- anti-anti-anti-anti-anti- anti-anti-anti-anti- anti-anti-anti-anti- anti-anti-anti-anti- an	Benefatta, 2020 a tempetata a constructiva de la construcción de la	Holman All Ma Holman Chronie Horpstein H
	The public Lie of the second s	History - Contract on the second seco	Carrees Per Large Per	Eugentalis 200 Hospitalis Constructions of the second seco	Norman Auf Marken Chroniel Norpeditud Grand Interpretation
	The public is a set of the set of	Historica in the second	Cancers Per- Cancers Per- Space Per- Person Person Per- Person Person Per- Person Per- Person Person	Eligitat Less Factor Light Less Light Less Table and many and the second secon	In the second of
	Republik de la constanti de la	High - Anise and Solution	Classes Jack Control of Control	benefates 200 million de benefates 200 mil	Roman Aur m Holdine Chronic Knoppfingelight Interpretation

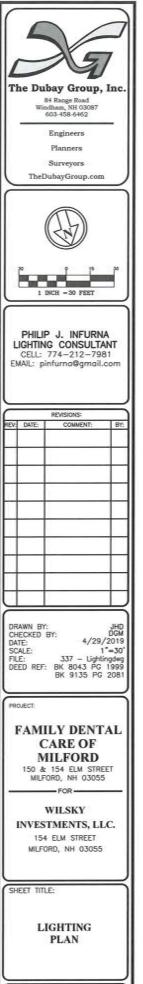

PROJECT #337 SHEET 8 of 15

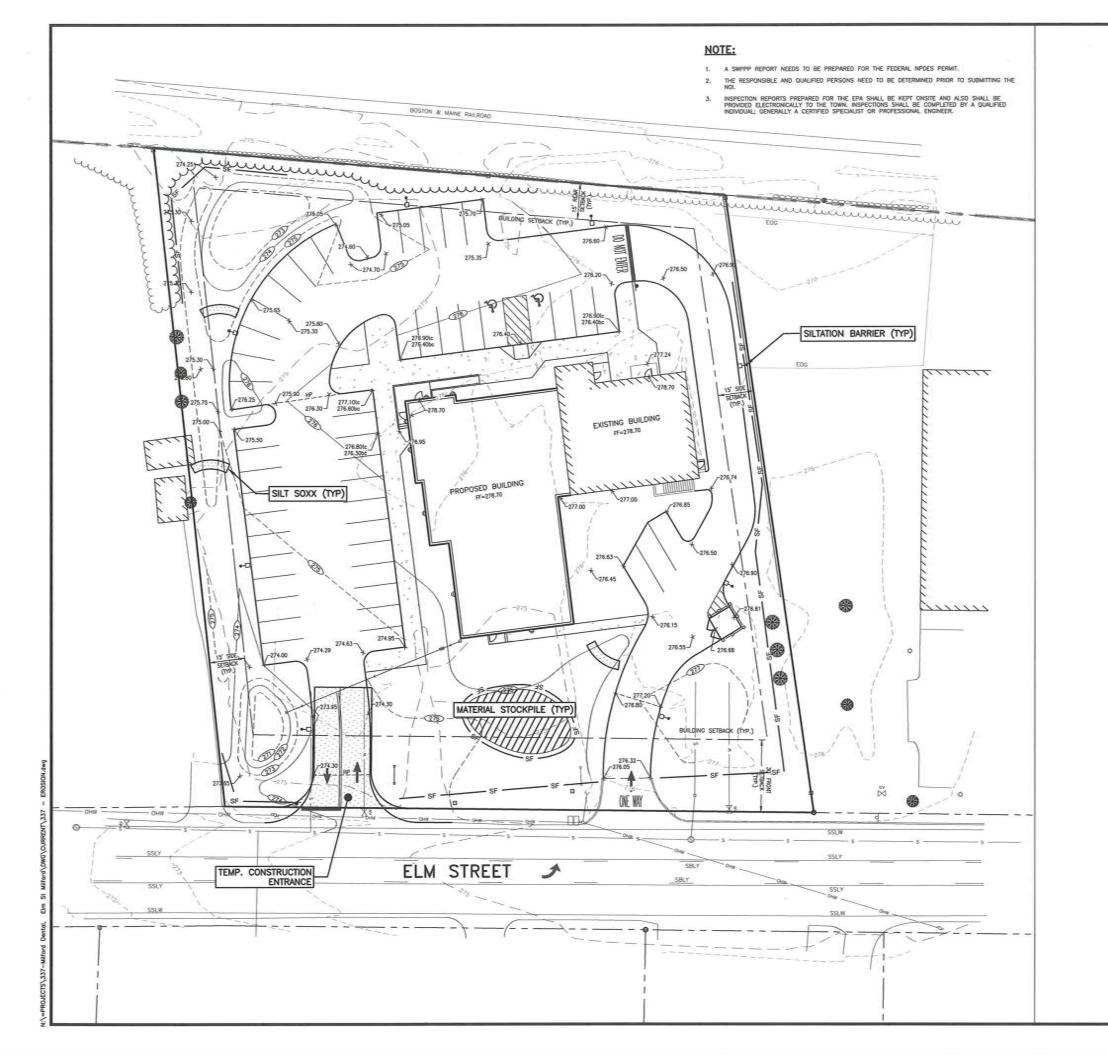

LEGEND:



STABILIZED TRACKING PAD

O CATCH BASIN PROTECTION (DANDY BAG)

-sf-sf-SILTATION BARRIER

BLANKET SLOPE PROTECTION

SOIL STOCK PILE AREA

The Dubay Group, Inc. 84 Range Road Windham, MH 03087 603-458-6462 Engineers Planners Surveyors TheDubayGroup.com					
~ ~					
REVISIONS: REV: DATE: COMMENT: BY:					
DRAWN BY: JHD CHECKED BY: REK DATE: 4/29/2019 SCALE: 1*=20' FILE: 337 - EROSION DEED REF: BK 8043 PG 1999 BK 9135 PG 2081					
PROJECT:					
FAMILY DENTAL CARE OF MILFORD 150 & 154 ELM STREET MILFORD, NH 03055					
FOR WILSKY INVESTMENTS, LLC. 154 ELM STREET MILFORD, NH 03055					
SHEET TITLE:					
EROSION CONTROL PLAN					
PROJECT #337 SHEET 9 of 15					

EROSION CONTROL NOTES

CONSTRUCTION SEQUENCE

- PRIOR TO CONSTRUCTION, AN INITIAL PRE CONSTRUCTION MEETING(S) SHALL TAKE PLACE WITH THE CONTRACTOR, OWNER, TOWN AGENTS.
- 2. THIS SITE WILL REQUIRE A USEPA NPDES PERMIT FOR STORMMATER DISCHARGE FOR THE SITE CONSTRUCTION SINCE THE DISTURBANCE EXCEEDS ONE ACRE. THE CONSTRUCTION SINCE THE SHALL DEVELOP AND IMPLEMENT A CONSTRUCTION STORM WATER POLULINON PREVENTION FUAN (SIMPP), WHICH SHALL REMAIN ON SITE AND MADE ACCESSIBLE TO THE PUBLIC. A COMPLETED NOTICE OF TERMINATION (NOT) SHALL BE SUBMITTED TO NPDES PERMITTING AUTHORITY WITHIN 30 DAYS AFTER EITHER OF THE FOLLOWING CONDITIONS HAVE BEEN MET: FINAL STABILIZATION HAS BEEN ACHIEVED ON ALL PORTIONS OF THE SITE FOR WHICH THE PERMITTEE IS RESPONSIBLE: OR ANOTHER OPERATOR/PERMITTEE HAS ASSUMED CONTROL OVER ALL AREAS OF THE SITE THAT HAVE NOT BEEN FINALLY STABILIZED.
- 3. INSTALL PERIMETER CONTROLS, LE SILT FENCE AND/OR SILTSOXX AROUND THE LIMITS OF DISTURBANCE REFORE MY FARTH WOMING OPERATION
- 4. CONSTRUCT TEMPORARY CONSTRUCTION EXIT.
- 5. CLEAR AND GRUB WITHIN AREAS OF DISTURBANCE UNLESS OTHERWISE NOTED.
- 6. REMOVE AND STOCKPILE MATERIALS AS REQUIRED. STOCKPILE SHALL BE SURROUNDED WITH AN EROSION CONTROL DEVICE TO PREVENT EROSION. STOCKPILE AREAS ARE LIMITED AND THUS MANAGEMENT OF MATERIALS WILL BE REQUIRED
- 7. SHAPE PROPOSED DRAINAGE PONDS. DITCHES AND/OR SWALES.
- 8. PERFORM ROUGH SITE GRADING, INSTALL ORAINAGE SYSTEMS AND UTILITIES.
- INSTALL UNDERGROUND UTILITIES AND PLACE EROSION CONTROL MEASURES AROUND ANY CATCH BASINS PRIGR TO DIRECTING ANY RUNNER TO THEM. ORANNACE SYSTEMS SHALL BE CONSTRUCTED AND STABILIZED PRIGR TO DIRECTING ANY FLOW TO THEM. ALL SIDE SLOPES SHALL BE STABILIZED WITHIN 72 HOURS.
- 10. LAYOUT AND INSTALL ALL BURIED UTILITIES AND SERVICES UP TO 10' OF THE PROPOSED BUILDING UNDATIONS, CAP AND MARK TERMINATIONS OR LOG SWING TIES
- FINISH GRADE SITE, BACKFILL ROAD SUBBASE GRAVEL IN. PROVIDE TEMPORARY EROSION PROTECTION TO DITCHES AND SWALES WHERE APPLICABLE, IN THE FORM OF MULCHING, JUTE MAITING OR STONE CHECK DAMAGE
- 12. ANY PERMANENT DITCHES AND SWALES SHALL BE STABILIZED PRIOR TO DIRECTING RUNOFF TO THEM.

13. PLACE BINDER LAYER OF PAVEMENT

- 14. AFTER ALL DRAINAGE AND RDADWAY IMPROVEMENTS (NOT INCLUDING FINAL LAYER OF PAVEMENT) HAVE BEEN COMPLETED, BEGIN CONSTRUCTION OF THE BUILDING FOUNDATIONS AND CONNECT TO SITE UTILITIES. BEGIN BUILDING CONSTRUCTION.
- PLANT LANDSCAPING IN AREAS OUT OF WAY OF BUILDING CONSTRUCTION. PREPARE AND STABILIZE FINAL SITE GRADING BY ADDING TOPSOIL, SEED, MULCH AND FERTILIZER.
- 16. AFTER BUILDINGS ARE COMPLETED, FINISH ALL REMAINING LANDSCAPED WORK.
- 17. CONSTRUCT ASPHALT WEARING COURSE.
- 18. REMOVE TRAPPED SEDIMENTS FROM COLLECTION DEVICES AS APPROPRIATE, AND THEN REMOVE TEMPORARY EROSION CONTROL MEASURES UPON COMPLETION OF FINAL STABILIZATION OF THE SITE.

GENERAL CONSTRUCTION NOTES

- THE TEMPORARY BMPS ASSOCIATED WITH THIS PROJECT WILL BE THE RESPONSIBILITY OF THE CONTRACTOR AND LANDOWNER, WHO WILL BE RESPONSIBLE FOR INSPECTION, OPERATION, AND MAINTENANCE.
- EROSION CONTROL PROCEDURES SHALL CONFORM TO SECTION 645 OF THE "STANDARD SPECIFICATION FOR ROAD AND BRIDGE CONSTRUCTION OF THE NHOOT... EROSION CONTROL SHALL BE INSTALLED DOWINHILL OF ALL AREAS WHERE WORK WILL EXPOSE UNPROTECTED SOIL TO PREVENT SEDWENT FROM ENTERING CATCH BASINS, DRAINAGE STRUCTURES AND/OR DRAINAGE WAYS. INSTALL TEMPORARY SEDWENT AND EROSION CONTROL WEASURES PRIOR TO ANY EARTH MOVING OPERATIONS. THE CONTRACTOR SHALL MANAGE THE PROJECT IN A WANKER THAT MEETS THE REQUIREMENTS AND INTENT OF RSA 430-53 AND CHAPTER AGR 3800 RELATIVE TO INVASIVE SPECIES.
- EROSION CONTROL DEVICES SHALL BE INSTALLED WHERE REQUIRED PRIOR TO ANY ON-SITE GRADING OR DISTURBANCE OF EXISTING SURFACE MATERIAL, EROSION CONTROL MEASURES SHALL BE MAINTAINED DURING DEVELOPMENT AND SHALL BE CHECKED PERIODICALLY AND EXCESS SITL SHALL BE REMOVED.
- 4. ALL DISTURBED AREAS WHICH ARE FINISH GRADED SHALL BE LOAMED (6" MINIMUM) AND SEEDED. SEE SEEDING AND FERTILIZER SPECIFICATION. SEE SLOPE DESIGN AND/OR LANDSCAPE PLAN FOR ADDITIONAL INFORMATION.
- ANY DISTURBED AREAS WHICH ARE TO BE LEFT TEMPORARILY, AND WHICH WILL BE REGRADED LATER SHALL BE MACHNED STRAW MULCH-BAND SEEDED WITH SLOPE STABILIZATION SEED MIXTURE TO PREVENT ERGSION. STRAW MULCH SHALL BE APPLIED AT A RATE OF 2 TONS/ACRE.
- ALL DRAINAGE SYSTEMS (DITCHES, SWALES, DRAINAGE PONDS/BASINS, ETC.) SHALL BE STABILIZED PRIOR TO DIRECTING RUNDEF TO THEM, STORNWARTER FLOWS ARE NOT TO BE DIRECTED TO THESE SYSTEMS UNTIL CONTRIBUTING AREAS HAVE ALSO BEEN FULLY STABILIZED.
- CONTRACTOR SHALL PROVIDE DUST CONTROL MEASURES IN ACCORDANCE WITH NHDES, EPA & TOWN REQUIREMENTS FOR THE DURATION OF THE PROJECT. WATER FOR DUST CONTROL SHALL BE PROVIDED ON SITE. FUGITIVE DUST IS CONTROLLED IN ACCORDANCE WITH EMA-A 1000.
- 8. ALL EROSION CONTROLS ARE TO BE INSPECTED WEEKLY AND AFTER 0.5" OR GREATER OF RAINFALL
- 9. ALL FILLS SHALL BE PLACED AND COMPACTED TO \$00% MODIFIED PROCTOR DENSITY IN LAYERS NOT EXCEEDING 18 INCHES IN THICKNESS UNLESS OTHERWISE NOTED. FILL MATERIAL SHALL BE FREE FROM STUMPS, WOOD, ROOTS, ETC. AND SHALL NOT BE PLACED ON FROZEN FOUNDATION SUBGRADE.
- 10. SLT FENCES AND/OR SUITSOXX SHALL BE PERIODICALLY INSPECTED DURING THE LIFE OF THE PROJECT IN AFTER EACH STORM. ALL DAMAGED SILT FENCES AND/OR SILTSOXX SHALL BE REPARED. SEDMENT EPOSITS SHALL PERIODICALLY BE REMOVED AND DISPOSED IN A SECURE LOCATION.

11. PAVED AREAS MUST BE KEPT CLEAN AT ALL TIMES.

- 12. ALL DEMATERING OPERATIONS MUST DISCHARGE DIRECTLY INTO A SEDIMENT FILTER AREA.
- 13. THE SMALLEST PRACTICAL AREA SHALL BE DISTURBED DURING CONSTRUCTION, BUT IN NO CASE SHALL EXCEED 5 ACRES AT ANY ONE TIME BEFORE DISTURBED AREAS ARE STABILIZED. ALL DISTURBED AREAS SHALL BE STABILIZED WITHIN 72 HOURS AFTER FINAL GRADING. EXPOSURE OF UNSTABILIZED SOLS SHALL BE TEMPORARILY STABILIZED AS SOON AS POSSIBLE BUT NO LATER THAN 45 DAYS OF INITIAL DISTURBANCE.
- 14. WINTERIZATION EFFORTS FOR AREAS NOT STABILIZED BY NOV. 1ST SHALL BE MADE BY THE APPROPRIATE USE OF MATTING, BLANKETS, MULCH AND SEEDING.
- 15. AN AREA SHALL BE CONSIDERED STABLE IF ONE OF THE FOLLOWING HAS OCCURRED:
- A. BASE COURSE GRAVELS HAS BEEN INSTALLED IN AREAS TO BE PAVED;
- B. A MINIMUM OF 85% VEGETATED CROWTH HAS REEN ESTABLISHED:
- C. A MINIMUM OF 3" OF NON-EROSIVE MATERIAL SUCH AS STONE OR RIP RAP HAS BEEN INSTALLED; OR

D. EROSION CONTROL BLANKETS HAVE BEEN PROPERLY INSTALLED.

16. IF, DURING CONSTRUCTION, IT BECOMES APPARENT THAT ADDITIONAL EROSION CONTROL MEASURES ARE REQUIRED TO STOP ANY EROSION ON THE CONSTRUCTION SITE DUE TO ACTUAL SITE CONDITIONS, THE CONTRACTOR SHALL BE REQUIRED TO IMMEDIATELY INSTALL AND MAINTAIN THE NECESSARY EROSION PROTECTION.

SEEDING SPECIFICATION

- 1. TEMPORARY SEED
- A TEMPORARY VEGETATIVE COVER SHOULD BE APPLIED WHERE EXPOSED SOIL SURFACES WILL NOT BE FINAL GRADED WITHIN 45 DAYS.
- B. SEED BED PREPARATION SHALL BE IN ACCORDANCE WITH THE NHOES STORMWATER MANAGEMENT MANUM VIOLINE 3 TEMPORARY VECTATION SECTION
- C. SEEDING

. SEEDING WIL	ATURE .		
MIXTURE	SPECIES	POUNDS PER ACRE	POUNDS PER 1,000 SQ. FT.
	WINTER RYE	112	2.50
	OATS	80	2.00
	ANNUAL RYEGRASS	40	1.00
	PERENNIAL RYEGRASS	30	0.17
	TOTAL	262	5.67

2. SEEDING SCHEDULE

- A. SPRING SEEDING USUALLY GIVES THE BEST RESULTS FOR ALL SEED MIXES OR WITH LEGUMES. B. PERMANENT SEEDING SHOULD BE COMPLETED 45 DAYS PRIOR TO THE FIRST KILLING FROST. SEEDING CANNOT BE DONE WITHIN THE SPECIFIED SEEDING DATES, MULCH ACCORDING TO THE HAMPSHIRE STORMWATER MANAGEMENT MANUAL, VOLUME 3, CONSTRUCTION PHASE BROSION SEDIMENT CONTROLS AND DELAY SEEDING UNTIL THE MEXT RECOMMENDED SEEDING PERIOD.
- 3 ESTABLISHING & STAND OF CRASS
- A. STONES AND TRASH SHOULD BE REMOVED FROM LOAMED AREAS SO AS NOT TO INTERFERE WITH THE SEEDING PROCESS.
- B. WHERE THE SOIL HAS BEEN COMPACTED BY CONSTRUCTION OPERATIONS, LODSEN SOIL TO A DEPTH OF 2 INCHES BEFORE APPLYING FERTILIZER, LIME AND SEED.
- C. IF APPLICABLE, FERTILIZER AND ORGANIC SOIL AMENDMENTS SHOULD BE APPLIED DURING THE GROWING
- D. APPLY LIMESTONE AND FERTILIZER ACCORDING TO SOIL TEST RECOMMENDATIONS. IF SOIL TESTING IS NOT FEASIBLE ON SMALL OR VARIABLE SITES, OR WHERE TIMING IS CRITICAL, FERTILIZER MAY BE APPLIED AT THE RATE OF 600 POUNDS PER ACRE OR 13.8 POUNDS PER 1,000 SQUARE FEET OF LOW PHOSPHATE FERTILIZER (N-P205-K20) OR EQUIVALENT, APPLY LIMESTONE (EQUIVALENT TO 50 PERCENT CALCIUM PLUS MAGNESIUM OXIDE) AT A RATE OF 3 TONS PER ACRE (138 LB. PER 1,000 SQUARE FEET).
- E. FERTUZER SHOULD BE RESTRICTED TO A LOW PHOSPHATE. SLOW RELEASE NUTROGEN FERTUZER
- 4. SEED SHOULD BE SPREAD UNFORMLY BY A METHOD MOST APPROPRIATE FOR THE SITE, METHODS INCLUDING HAND, CYCLONE SEEDER, DRILL, CULTIPACKER, TYPE, SEEDER, OR, HYDROSEEDER A. INOCULATE ALL LEGUME SEED WITH THE CORRECT TYPE AND AMOUNT OF INOCULANTS.
- B. NORMAL SEEDING DEPTH IS FROM ½ TO ½ INCH. HYDROSEEDING THAT INCLUDES MULCH MAY BE LEFT ON SOIL SURFACE. SEEDING RATES MUST BE INCREASED 10 % WHEN HYDROSEEDING.
- C. WHERE FEASIBLE, EXCEPT WHERE EITHER A CULTIPACKER TYPE SEEDER OR HYDROSEEDER IS USED, THE SEEDBED SHOULD BE FIRMED FOLLOWING SEEDING OPERATIONS WITH A ROLLER, OR LIGHT DRAG.
- D. THE GRADE "A" OF SEEDING MIXTURE SHOULD BE USED WITH THE FOLLOWING SEEDING RATES. BASED

MIXTURE	SPECIES	POUNDS PER ACRE	POUNDS PER 1,000 SQ. FT.
A	TALL FESCUE	20	0.45
	CREEPING RED FESCUE	20	0.45
	REDTOP	2	0.05
	TOTAL	42	0.95


- 5. ALTERNATE PERMANENT SEEDING FOR AREAS NOT RECEMING LAWN OR LANDSCAPING SHALL BE AS
- A THE NEW ENGLAND FROSION CONTROL /RESTORATION MIX CONTAINS & SELECTION OF NATIVE CRASSES THE NEW ENGLAND EROSION CONTROL/RESTORATION MIX CONTAINS A SELECTION OF NATIVE GRASSES AND WILDFLOWERS DESIGNED TO COLUNIZE GENERALLY MOIST, RECENTLY DISTURBED SITES WHERE QUICK GROWTH OF VEGETATION IS DESIRED TO STABILIZE THE SOIL SURFACE. THIS MIX IS PARTICULARLY APPROPRIATE FOR DETENTION BASINS WHICH DO NOT NORMALLY MOLD STANDING WATER. THE FLANTS IN THIS MIX CAN TOLERATE INFREQUENT INUNDATION, BUT NOT CONSTANT FLOODING. IN NEW FOLLAND, THE BEST RESULTS ARE OBTINUED WITH A SPRING OR EARLY FAIL SEEDING, SUMMER AND FAIL SEEDING CAN BE SUCCESSFUL WITH A UCHT MULCHING OF WEED-FREE STRAW TO CONSERVE MOISTURE. LATE FAIL AND WITTER DORMANT SEEDING REQUIRE A SUGHT INCREASE IN THE SEEDING RATE. FERTILDATION IS NOT REQUIRED UNLESS THE SOLS ARE PARTICULARLY INFERTULE.
- B. APPLICATION RATE: 35 LBS/ACRE 1245 SQ FT/LB
- C. SPECIES: SWITCHGRASS (PANICUM VIRGATUM), CREEPING RED FESCUE (FESTUCA RUBRA), VIRGINIA WILD RYE (ELYMUS VIRGINICUS), FOX SEDGE (CAREX VULPINODEA), CREEPING BENTGRASS (ACROSTIS THE (ELIMUS WINAMOUS), FOX SEDE (CARA YOU MOUDS), UNEWARGOLD (BUDINS ESMUA), SOFT STOLONFERA, SIKY WIL BRE (ELIMUS VILLOSUS), NOODING BUR-WARGOLD (BUDINS ESMUA), SOFT RUSH (JUNCUS EFFUSUS), GRASS-LEAVED COLLENROD (SOLDAGO GRAMINFOLM), SENSITIE FERM (ONOCLEA SENSIBILS), JOE-PYE WEED (EUPATORIUM MACULATUM), BONESET (EUPATORIUM PERFOLATUM), FLAT-TOP ASTER (ASTER UMBELLATUS), NEW YORK ASTER (ASTER NOVI-BELGI), BLUE VERVAIN (VERBENA HASTATA)

WINTER NOTES

- ALL PROPOSED VEGETATED AREAS WHICH DO NOT EXHIBIT A MINIMUM OF 85% VEGETATIVE GROWTH BY OCTOBER 15TH, OR WHICH ARE DISTURBED AFTER OCTOBER 15TH, SHALL BE STABILIZED BY SEEDING AND INSTALLING EROSION CONTROL BLANKETS ON SLOPES GREATER THAN 3:1, AND SEEDING AND PLACING 3 TO 4 TONS OF MULCH PER ACRE, SECURED WITH AND/GREEN NETTING, ELSEWHERE. THE INSTALLATION OF EROSION CONTROL BLANKETS OR MULCH AND NETTING SHALL NOT OCCUR OVER ACDIMULATED SNOW OR ON FROZEN GROUND AND SHALL BE COMPLETED IN ADVANCE OF THAW OR SPRING MELT EVENTS;
- ALL AREAS TO BE PLANTED WHICH DO NOT EXHIBIT A MINIMUM OF 85% VEGETATIVE GROWTH BY OCTOBER 15TH, OR WHICH ARE DISTURBED AFTER OCTOBER 15TH, SHALL BE STABILIZED TEMPORARILY WITH STONE OR EROSION CONTROL BLANKETS APPROPRIATE FOR THE DESION FLOW CONTRONS.
- AFTER NOVEMBER 15TH, INCOMPLETE SURFACES TO BE PAVED, WHERE WORK HAS STOPPED FOR THE WINTER SEASON, SHALL BE PROTECTED WITH A MINIMUM OF 3 INCHES OF CRUSHED GRAVEL PER NHDDT ITEM 304.3 OR CRUSHED STONE.

MAINTENANCE AND PROTECTION

- 1. THE CONTRACTOR SHALL TAKE WHATEVER WEASURES ARE NECESSARY TO PROTECT THE GRASS WHILE IT DEVELOPS.
- TO BE ACCEPTABLE, SEEDED AREAS SHALL CONSIST OF A UNIFORM STAND OF AT LEAST 90 PERCENT ESTABLISHED PERMANENT GRASS SPECIES, WITH A UNIFORM COUNT OF AT LEAST 100 PLANTS PER SOLIARE FOOT
- 3. SEEDED AREAS WILL BE FERTILIZED AND RE-SEEDED AS NECESSARY TO INSURE VEGETATIVE
- 4. THE SWALES WILL BE CHECKED WEEKLY AND REPARED WHEN NECESSARY, UNTIL ADEQUATE VEGETATION
- 5. THE SLT FENCE AND/OR SILTSOXX BARRIER SHALL BE CHECKED AFTER EACH RAINFALL AND AT LEAST
- 6. SILT FENCE AND/OR SILTSOXX SHALL BE REMOVED ONCE VEGETATION IS ESTABLISHED, AND DISTURBED AREAS RESULTING FROM SUIT FENCE AND/OR SILTSOXX REMOVAL SHALL BE PERMANENTLY SEEDED.

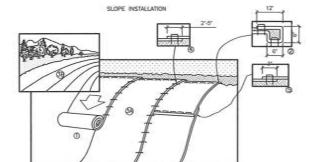

PREPARE SOIL BEFORE INSTALLING BLANKETS, INCLUDING ANY NECESSARY APPLICATION OF LIME, FERTILIZER, AND SEED. NOTE: WHEN USING CELL-O-SEED DO NOT SEED PREPARED AREA. CELL-O-SEED MIST DE INSTALLED WITH PAPER SDIE DOWN.

2. BEGIN AT THE TOP OF THE SLOPE BY ANCHORING THE BLANKET IN A 6" DEEP X 6" WIDE TRENCH WITH APPROXIMATELY 12" OF BLANKET EXTENDED BEYOND THE UP-SLOPE PORTION OF THE TRENCH. ANCHOR THE BLANKET WITH A ROW OF STAPLES/STAKES APPROXIMATELY 12" APART IN THE BOTTOM OF THE TRENCH BACKTILL AND COMPACT THE TRENCH ATER STAPLING. APPLY SEED TO COMPACTED SOIL AND FOLD REMAINING 12" PORTION OF BLANKET BACK OVER SEED AND COMPACTED SOIL. SECURE BLANKET OVER COMPACTED SOIL WITH A ROW OF STAPLES/STAKES SPACED APPROXIMATELY 12" APART ACROSS THE WIDTH OF THE BLANKET.

3. ROLL THE BLANKETS (A.) DOWN OR (B.) HORIZONTALLY ADROSS THE SLOPE. BLANKETS WILL UNROLL WITH APPROPRIATE SIDE AGAINST THE SOIL SUFFACE. ALL BLANKETS MUST BE SECURELY FASTENED TO SOIL SUFFACE BY PLACING STAFLES/STAKES IN APPROPRIATE LOCATIONS AS SHOWN IN THE STAFLE PATTERN GUIDE. WHEN USING OPTIONAL DOT STSTEM, STAFLES/STAKES SHOULD BE PLACED THROUGH EACH OF THE COLORED DOTS CORRESPONDING TO THE APPROPRIME STAFLE FATTERN.

4. THE EDGES OF PARALLEL BLANKETS MUST BE STAPLED WITH APPROXIMATELY 2"-5" OVERLAP DEPENDING ON BLANKET TYPE. TO ENSURE PROPER SEAM AUGNMENT, PLACE THE EDGE OF THE OVERLAPPING BLANKET (BLANKET BEING INSTALLED ON TOP) EVEN WITH THE COLORED SEAM STITCH ON THE PREVIOUSLY INSTALLED BLANKET.

5. CONSECUTIVE BLANKETS SPLICED DOWN THE SLOPE MUST BE PLACED END OVER END (SHINCLE STYLE) WITH AN APPROXIMATE 3" OVERLAP. STAPLE THROUGH OVERLAPPED AREA, APPROXIMATELY 12" APART ACROSS ENTRE BLANKET WOTH.

6. IN LOOSE SOIL CONDITIONS, THE USE OF STAPLE OR STAKE LENGTHS GREATER THAN 6" MAY BE NECESSARY TO PROPERLY SECURE THE BLANKETS.


7. INSTALL PRODUCT IN ACCORDANCE WITH MANUFACTURER'S SPECIFICATIONS.

8. MATTING IS REQUIRED ON ALL SLOPES STEEPER THAN 3:1.

SLOPE PROTECTION EROSION CONTROL MATTING

(THIS DETAIL IS PROVIDED FOR AREAS THAT MAY REQUIRE


NOT TO SCALE ADDITIONAL PROTECTION BASED ON FIELD CONDITIONS.)

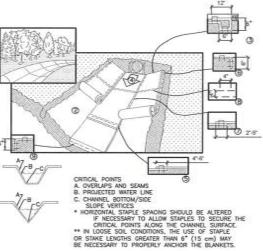

NOT TO SCALE (THIS DETAIL IS PROVIDED FOR AREAS THAT MAY REQUIRE ADDITIONAL PROTECTION BASED ON FIELD CONDITIONS.

MATTING INSTALLATION NOTES

CHANNEL INSTALLATION SPECIFICATIONS

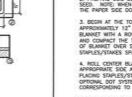

1. INSTALL PRODUCT IN ACCORDANCE WITH MANUFACTURER'S SPECIFICATIONS

PREPARE SOIL BEFORE INSTALLING BLANKETS, INCLUDING ANY NECESSARY APPLICATION OF LINE, FERTILIZER, AND SEED. MORE: WHEN USING CELL-0-SEED, DO NOT SEED PREPARED AREA. CELL-0-SEED MUST BE INSTALLED WITH THE PARER SDE DOWN.

3. BEON AT THE TOP OF THE CHANNEL BY ANCHORING THE BLANKET IN A STDEEP X 5" WIDE TRENCH WITH APPROXIMATELY 12" OF BLANKET EXTENDED BEYOND THE UP-SIDE PORTION OF THE TRENCH. ANCHOR THE BLANKET WITH A ROW OF STAPLES/STAKES APPROXIMATELY 12" APART IN THE SOTTOM OF THE TRENCH. BAC AND COMPACT THE TRENCH AFTER STAPLING. APPLY SEED TO COMPACTED SOL, AND FOLD REMAINSD 12" P OF BLANKET OVER SEED AND COMPACTED SOL. SCILE BLANKET OVER COMPACTED SOL, WITH A ROW OF STAPLES/STAVES SPACEL APPROXIMATILY 12" APART ARCIDS THE WOTH OF THE BLANKET. * PORTION

4. ROLL CENTER BLANKET IN DIRECTION OF WATER FLOW IN BOTTOW OF CHANNEL. BLANKETS WILL UNROLL WITH APPROPRATE SDE AGAINST THE SOIL SURFACE. ALL BLANKETS MUST BE SECURELY FASTENED TO SOIL SURFACE BY PLACING STAFLES/STAKES IN APPROPRIATE IS LANGLOATIONS AS SHOWN IN THE STAFLE PATTERN UNDE. WHEN USING OPTIONAL, DOT SYSTEM, STAPLES/STAKES SHOULD BE PLACED THROUGH EACH OF THE COLORED DOTS CORRESPONDING TO THE APPROPRIATE STAFLE PATTERN.

5. PLACE CONSECUTIVE BLANKETS END OVER END (SHINGLE STILE) WITH A 4"-6" OVERLAP. USE A DOUBLE ROW OF STAPLES STAGGERED 4" APART AND 4"(10") ON CENTER TO SECURE BLANKETS.

6. FULL-LENGTH EDGE OF BLANKETS AT TOP OF SIDE SLOPES MUST BE ANCHORED WITH A ROW O STAPLES/STARES APPROXIMATELY 12" APART IN A 6'DEEP X 6" WIDE TRENCH. BACKFILL AND CON TRENCH AFTER STAPLING. ACT THE

7. ADJACENT BLANKETS MUST BE OVERLAPPED APPROXIMATELY 2°-5" (DEPENDING ON BLANKET TIPE) AND STAPLED TO ENSIBLE PROPER SEM AUDMENT, PLACE THE EDEC OF THE OVERLAPPING BLANKET (BLANKET BEING OVERLAPPED) ON TOP' (EVD) WITH THE COLORED SEM STITUTION ON THE BLANKET BEING OVERLAPPED.

8. IN HIGH FLOW CHANNEL APPLICATIONS, & STAPLE CHECK SLOT IS RECOMMENDED AT 30' TO 40' INTERNALS. USE A DOUBLE ROW OF STAPLES STAGGERED 4" APART AND 4" ON CENTER OVER ENTIRE WOTH OF CHANNEL.


THE TERMINAL END OF THE BLARKETS MUST BE ANCHORED WITH A ROW OF STAPLES/STAKES APPROXIMATELY 12" APART IN A 6'DEEP X 6'WIDE TRENCH. BACKFILL AND COMPACT THE TRENCH AFTER STAPLING.

ROLLED EROSION CONTROL MATTING

5 The Dubay Group, Inc. 84 Range Road Windham, NH 0308 603-458-6462 Engineers Planners Surveyors TheDubayGroup.com REVISIONS COMMENT EVI DATE: BY: DRAWN BY REK 4/29/2019 CHECKED BY: DATE: SCALE: AS NOTED FILE: 337 - DETAILS DEED REF: BK 8043 PG 1999 BK 9135 PG 208 PROJECT: FAMILY DENTAL CARE OF MILFORD 150 & 154 ELM STREET MILFORD NH 03055 FOR WILSKY INVESTMENTS, LLC. 154 FLM STREET MILFORD, NH 03055 SHEET TITLE:


SITE **DETAILS-1**


PROJECT #337 SHEET 10 of 15

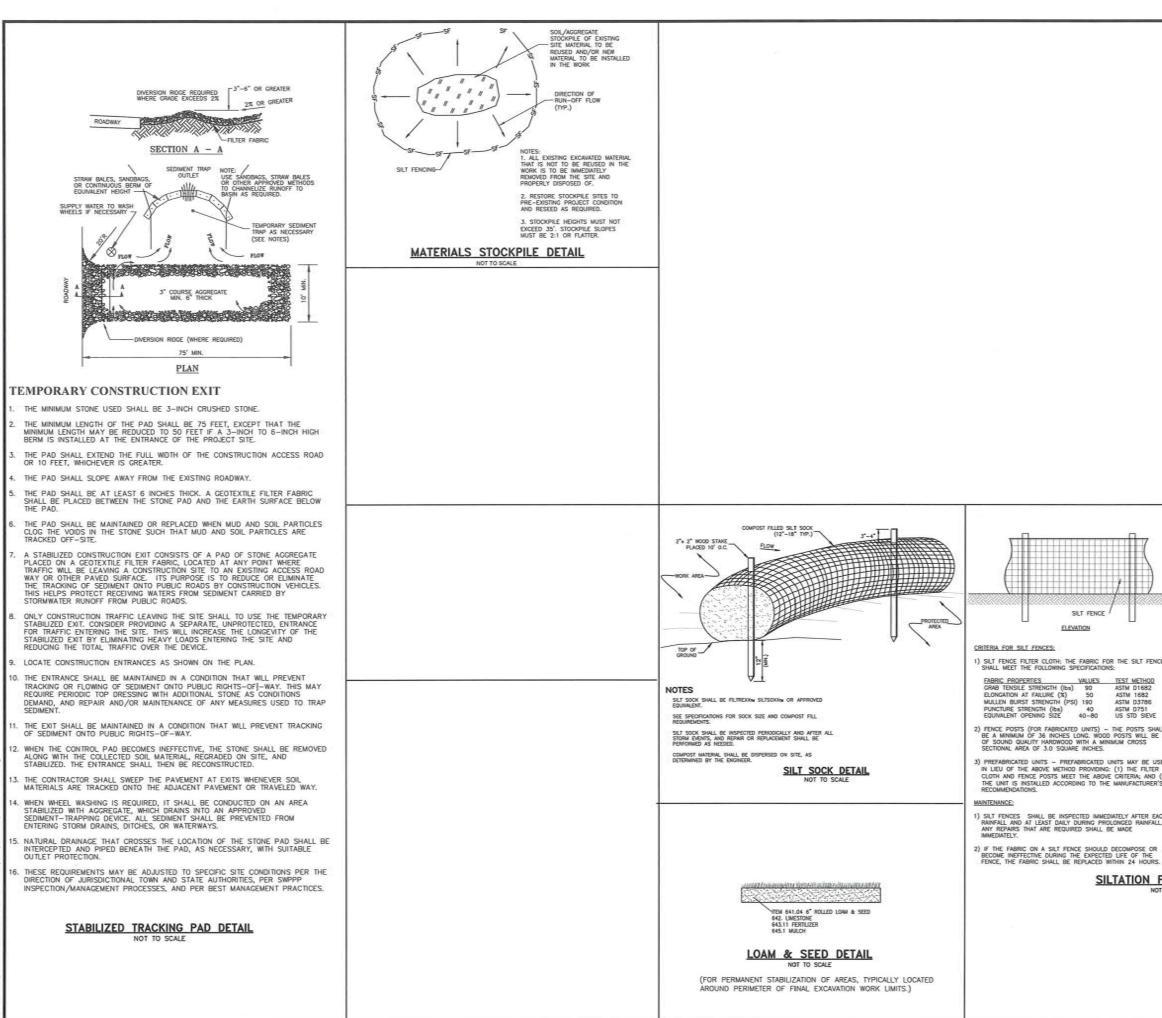


IS\337-Milford Dentel. Eim St Milford\DWG\CURREN

	The Dubay Group, Inc. St Range Road Windham, NH 00007 603-458-6462 Engineers Planners Surveyors TheDubayGroup.com
I-3/4"XI-3/4" (WIN) METAL OR WOOD POST OR STAKE URECTION OF RUNGE FLOW OLD GROUND OLD GROUND OLD GROUND OLD GROUND MATERIAL, IF REQUIRED END. VIEW	
 3) SEDIMENT DEPOSITS SHOULD BE INSPECTED AFTER EVERY STORM EVENT. THE DEPOSITS SHOULD BE REMOVED WHEN THEY REACH APPROXIMATELY ONE-HALF THE HEIGHT OF THE BARRIER. 4) SEDIMENT DEPOSITS THAT ARE REMOVED OR LEFT IN PLACE AFTER THE FABRIC HAS BEEN REMOVED SHALL BE GRADED TO CONFORM WITH THE EXISTING TOPOGRAPHY AND VEGETATED. 	DRAWN BY: JHD CHECKED BY: REK DATE: 4/29/2019 SCALE: AS NOTED FILE: 337 - DETALS DEED REF: BK 8043 PG 1999 BK 9135 PG 2081
CONSTRUCTION SPECIFICATIONS: HALL 1) THE GEOTEXTILE FABRIC SHALL MEET THE DESIGN CRITERA FOR SLIT FROMES. HALL 1) THE GEOTEXTILE FABRIC SHALL MEET THE DESIGN CRITERA (MID_THE_GROUND AND THE SOL COMPACTED OVER THE DMEDDED FABRIC. USED 3) FILTER CLOTH SHALL BE FASTENED SECURELY TO THE WOODEN STARES EVERY 12 NCHES. N° 3) FILTER CLOTH SHALL BE FASTENED SECURELY TO THE WOODEN STARES EVERY 12 NCHES. N°S 4) MEEN TWO SECTIONS OF FILTER CLOTH ADJOIN EACH OTHER, THEY SHALL BE CHERAPED BY 6 MCHES, FOLDED, AND STAPLED TO MOOD STARE. CACH 5) POSTS SHALL BE A MINIMUM OF 36 INCHES LONG AND DRIVEN A MINIMUM OF 16 INCHES INTO THE GROUND, AND OF SOUND QUALITY HARDMOOD AND SHALL HAVE A MINIMUM CRISS SECTIONAL AREA OF 3.0 SQUARE INCHES. R 6) MANTENANCE SHALL BE PERFORMED AS INCHES. R 6) MANTENANCE SHALL BE FASTENED DAS NEEDED TO PREVENT BUILDES IN THE SILT FENCE DUE TO DEPOSITION OF SEDMENT. FENCING DETAIL WOT TO SCALE	PROJECT: FAMILLY DENTAL CARE OF MILFORD 150 & 154 ELM STREET MILFORD, NH 03055 FOR WILSKY INVESTMENTS, LLC. 154 ELM STREET MILFORD, NH 03055 SHEET TITLE:
	SITE DETAILS-2
	(PROJECT #337 SHEET 11 of 15)

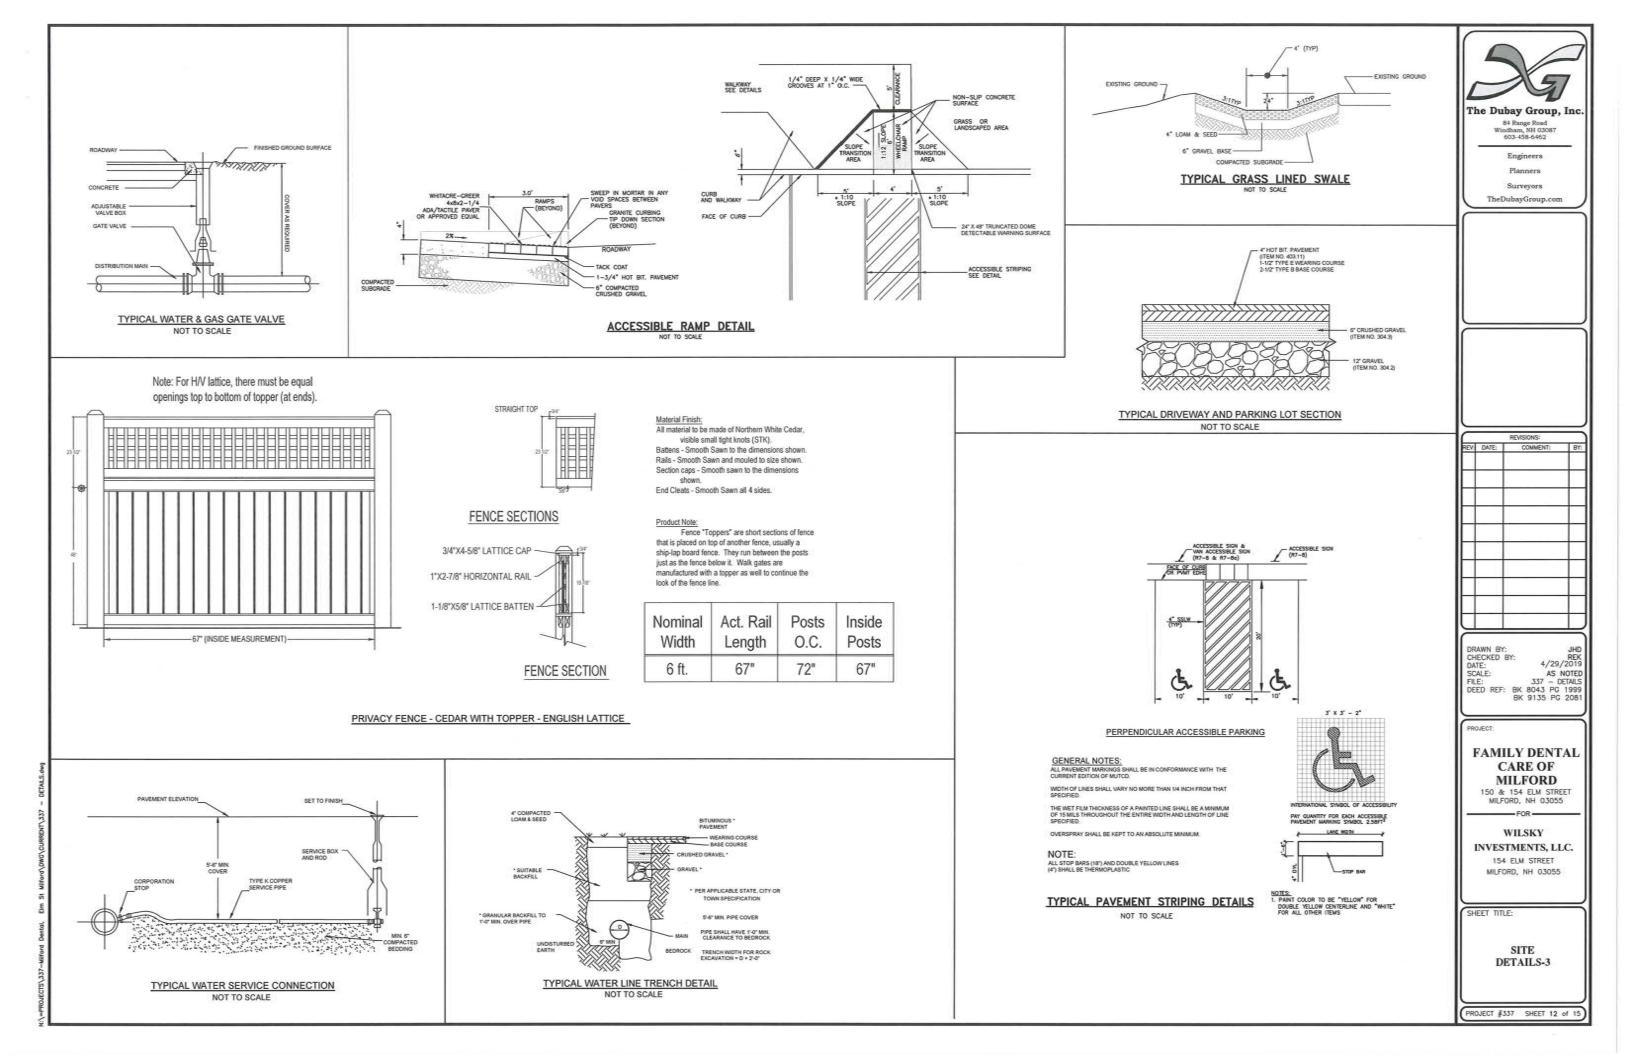

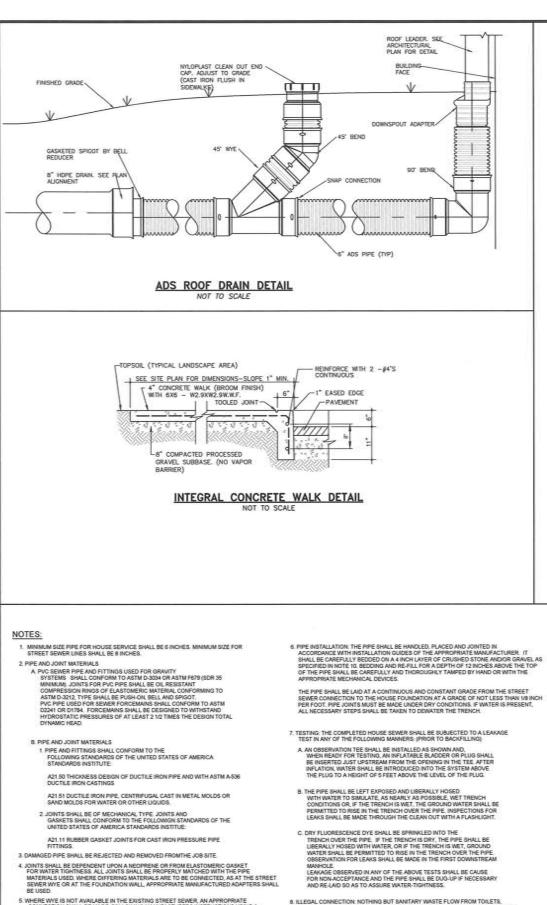

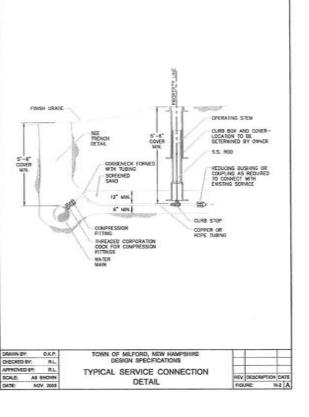


BE OGED. 5 WHERE WYE IS NOT AVAILABLE IN THE EXISTING STREET SEWER, AN APPROPRIATE CONNECTION SHALL BE MADE, FOLLOWING MANUFACTURERS INSTRUCTIONS USING A BOLTED, CLAIPED, OR FPOXY-CEMENTED SADDLE TAPPED INTO A SMOOTHLY DRILLED OR SAWM OPENING IN THE SEWER THE PRACTICE OF BREAKING AN OPENING WITH A SLEDGE HAMMER, STUFFING CLOTH OR OTHER SWOL MATERIAL AROUND THE JOINT, OR APPLYING MORTAR TO HOLD THE CONNECTION, AND ANY OTHER SIMILAR CRUDE PRACTICES OR INEPT OR HISTY WIRROWSATIONS WILL NOT BE PREMITTED. THE CONNECTION SHALL BE COMCRETE ENCASED AS SHOWN IN THE DETAIL.

- 8 ILLEGAL CONNECTION: NOTHING BUT SANITARY WASTE FLOW FROM TOILETS. SINKS, LAUNDRY FITC. SHALL BE PERMITTED. ROOF LEADERS, FOOTING DRAINS O SUMP FUNKS OF ANY OTHER SIMLAR CONNECTION CARRYING RAIN WATER, DRA OR GROUND WATER, SHALL NOT BE PERMITTED.
- 9. WATER SERVICE SHOULD NOT BE LAID IN SAME TRENCH AS SEMER SERVICE. BUT WHEN NECESSARY, SHALL BE PLACED ABOVE AND TO ONE SIDE OF THE SEMER AS
- 10 LOCATION: THE LOCATION OF THE TEE SHALL BE RECORDED AND FILED IN LUCATION: THE UNITAL RECORDS. IN ADDITION, A FERROUS MADE AND FILED IN THE MUNICIPAL RECORDS. IN ADDITION, A FERROUS MATERIAL, ROO OR PIPE SHALL BE PLACED OVER THE WYE TO AID IN LOCATING THE BURIED PIPE WITH A DIP NEEDLE OR PIPEFINDER.

11. CHIMNEYS: NOT PERMITTED

12 UNLESS OTHERWISE NOTED ALL GRANULAR MATERIAL SHALL BE PLACED IN 12" LIFTS AND COMPACTED TO 92% OF THE MODIFIED PROCTOR TEST.

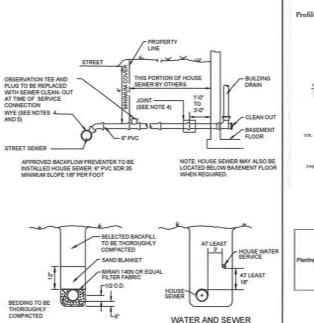

WATER AND SEWER

IN SAME TRENCH


BEDDING TO BE

THOROUGHLY COMPACTED

TRENCH CROSS-SECTION

SANITARY SEWER SERVICE DETAIL

NOT TO SCALE

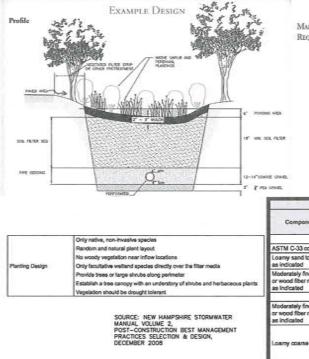

BIORETENTION SYSTEM - "RAIN GARDEN" [

			The Dubay Group, Inc. S4 Range Road Windham, NH 03087 603-458-6462 Engineers Planners Surveyors TheDubayGroup.com
rainfall event of stenance or re ection. reatment mea	exceeding 2.5 habilitation or sures should b alated sedimer	test twice somuly, and following inches in a 24 hour period, with anducted as warranted by such inspected at least twice annually, and at as warranted by inspection, but no	DRAWN BY: SHB CHECKED BY: ACS DATE: 4/29/2019 SCALE: AS NOTED FILE: 337 - DETALS DEED REF: BK 8043 PG 1999
h and debois s rate once annu occention sys fall event, the effective to de tion or infilm red to removal r media. reation should thy condition, l or diseased u	hould be rems teen does not n a qualified p cosmine mean ation function l of accumulat l be inspected , including pro	ord at each inspection. and be inspected for drawdows time, dian within 72-hours following a rofenional should assess the condition user required to retrate filteration (as applicable), including but not ed seliments or reconstruction of the at least annually, and maintained in using, removal and replacement of removal of instaires fits Gradation of Matarial Percent by Weight Passing Standard Sizes	PROJECT: FAMILY DENTAL CARE OF MILFORD 150 & 154 ELM STREET MILFORD, NH 03055 FOR WILSKY INVESTMENTS, LLC.
Filter Media C to 55 to 30 to 30	200 200	15 to 25 <5	154 ELM STREET MILFORD, NH 03055
Itter Media C	200 200 10 20 60 200	< 5 85 to 100 70 to 100 15 to 40 8 to 15	SHEET TITLE: SITE DETAILS-4
DETAIL			PROJECT #337 SHEET 13 of 15

MAINTENANCE REQUIREMENTS

 Syst anyı mait insp


 Prett dear less t

Trail

• At le If bi rainfr of th func lini film

Vegs heah dead

		Gradation of Material		
ent Material	Percent of Mixture by Volume	Sleve No.	Percent by Weight Passing Standard Sleve	
	Filter Media	Option A		
oncrete sand	50 to 55			
opsoil, with fines	20 to 30	200	15 lo 25	
e shredded bark nuich, with lines	20 to 30	200	<5	
	Filter Media	Option B		
e shredded bark nuich, with fines	20 to 30	290	<5	
	70 to 80	10	85 to 100	
sand		20	70 to 100	
		60	15 lo 40	
		200	8 to 15	

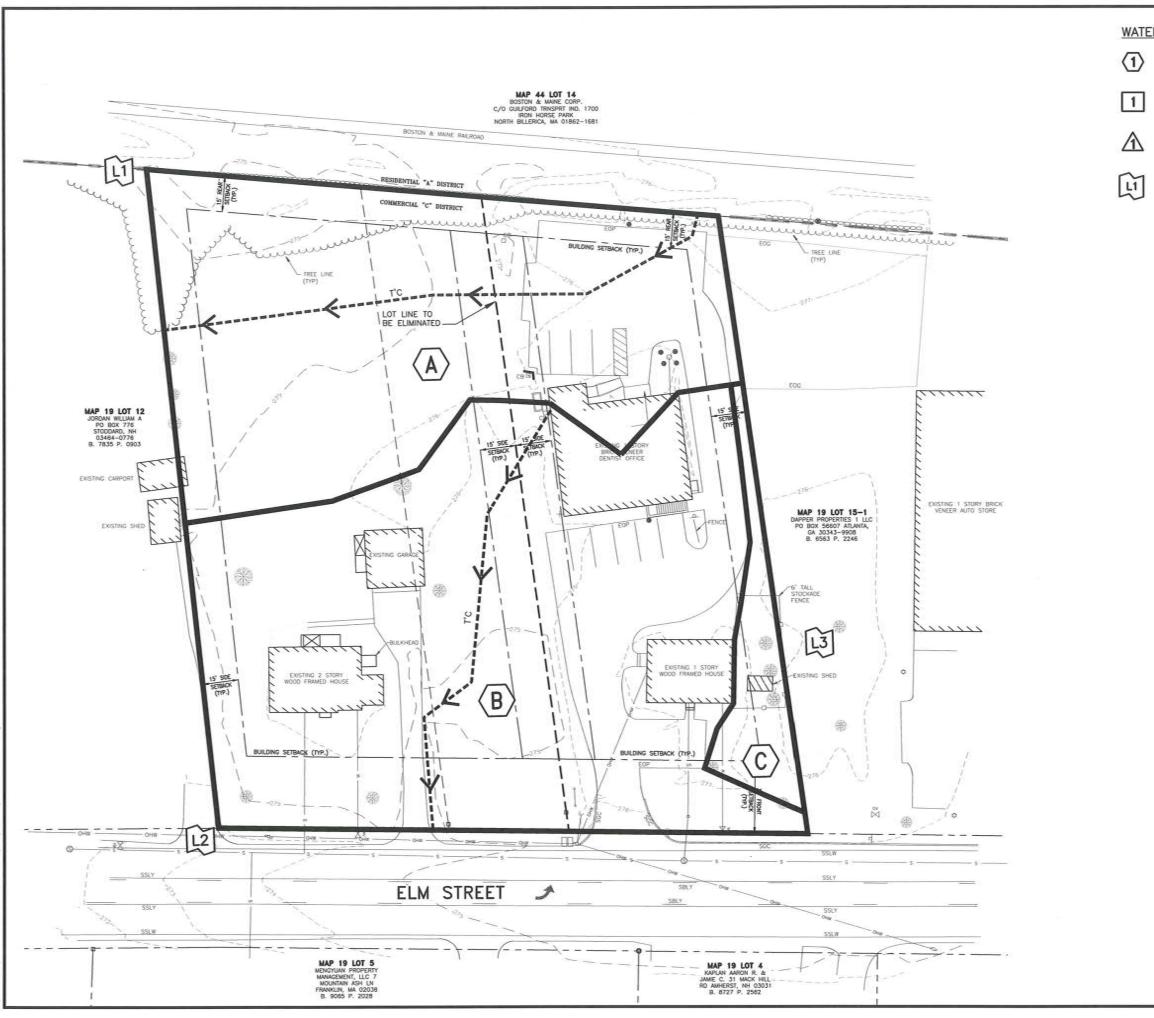

WATERSHED LEGEND:


SUBCATCHMENT: A RELATIVELY HOMOCENEOUS AREA OF LAND THAT DRAINS INTO A SINGLE REACH OR POND. EACH SUBCATCHMENT GENERATES A RUNOFF HYDROGRAPH. (A SUBCATCHMENT MAY LASS DE USED TO ACCOUNT FOR THE RAIN FALLING DIRECTLY ON THE SUBFACE OF A POND.)

REACH: A UNIFORM STREAM, CHANNEL, OR PIPE THAT CONVEYS WATER FROM ONE POINT TO ANOTHER REACH OR POND. THE OUTFLOW OF EACH REACH IS DETERMINED BY A HYDROGRAPH ROUTING CALCULATION.

POND: A POND, SWAMP, DAW, OR OTHER IMPOUNDMENT THAT FILLS WITH WATER FROM ONE OR WORE SOURCES AND EMPTIES IN A MANNER DETERMINED BY A WER, CULVERT, OR OTHER DEVICE(S) AT ITS OUTLET. THE OUTFLOW(S) OF EACH POND IS DETERMINED BY A HYDROGRAPH ROUTING CAUCULATION. THE PRIMARY AND/OR SECONDARY OUTFLOW MAY DRAIN INTO A REACH OR INTO ANOTHER POND.

LINK: A METHOD OF INTERCONNECTING SEVERAL HYDROGRAPHS WHICH MAY CONVERGE TOGETHER AT A COMMON ANALYSIS POINT.

The Dubay Group, Inc. Bit Range Road Windham, Rho d0087 603-458-6462 Engineers Planners Surveyors TheDubayGroup.com				
REVISIONS: REV DATE: COMMENT: BY: DATE: COMMENT: BY: DATE: COMMENT: BY: DATE: DATE: DATE: BY: DATE: COMMENT: BY: DRAWN BY: DATE: DCM				
рате: 4/29/2019 SCALE: 1"=20" FILE: 337 - PRE-DEVELOP DEED REF: BK 8043 PG 1999 BK 9135 PG 2081 PROJECT: FAMILLY DENTAL CARE OF MILFORD 150 & 154 ELM STREET MILFORD, NH 03055 				
WILSKY INVESTMENTS, LLC. 154 ELM STREET MILFORD, NH 03055 SHEET TITLE: PRE-DEVELOPMENT WATERSHED PLAN				

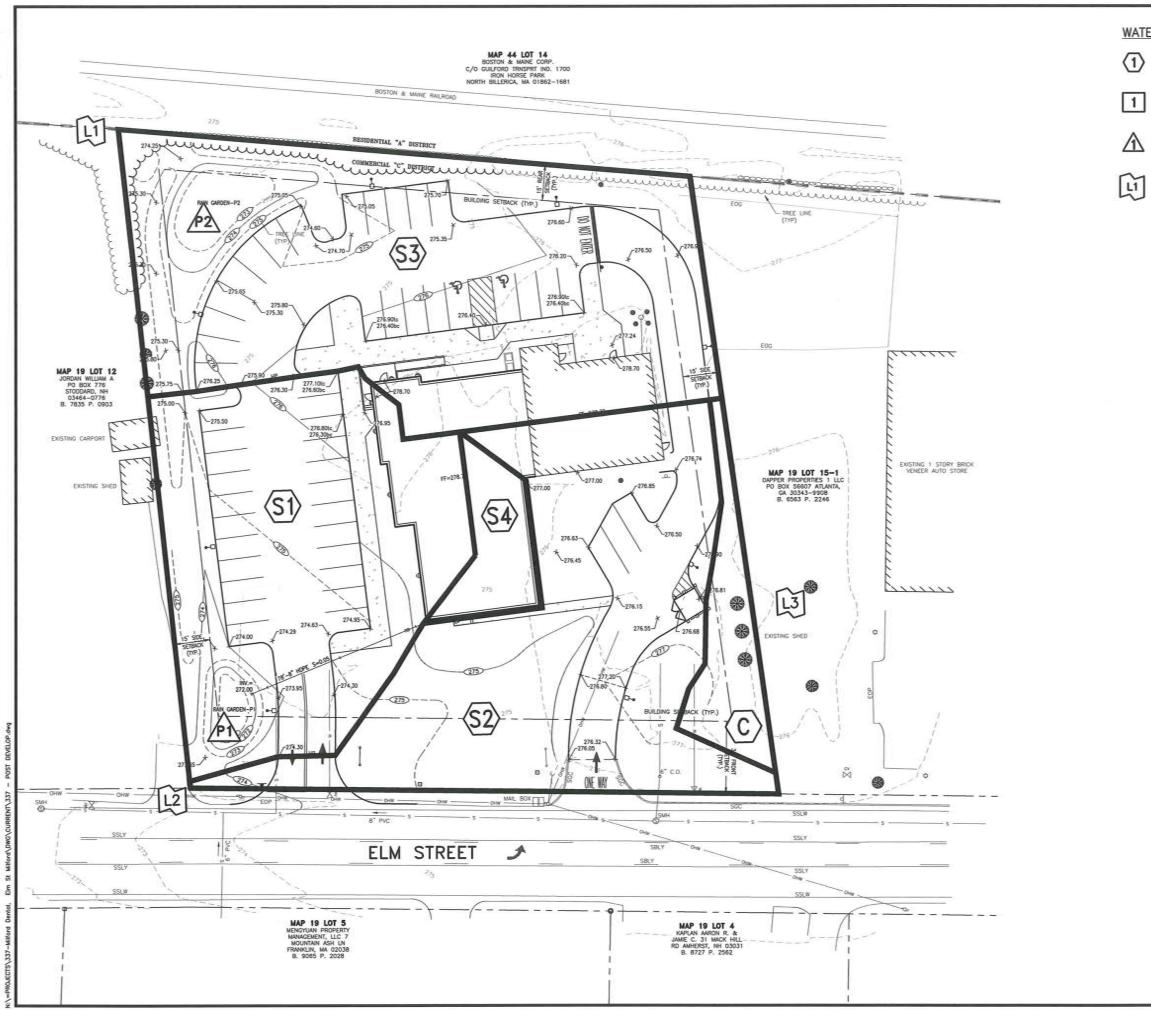

WATERSHED LEGEND:

SUBCATCHMENT: A RELATIVELY HOWOGENEOUS AREA OF LAND THAT DRAINS INTO A SINGLE REACH OR POND. EACH SUBCATCHMENT GENERATES A RUNOFF MTORGRAPH. (A SUBCATCHMENT MAY LASS BE USED TO ACCOUNT FOR THE RAIN FALLING DIRECTLY ON THE SURFACE OF A POND.)

REACH: A UNIFORM STREAM, CHANNEL, OR PIPE THAT CONVEYS WATER FROM ONE POINT TO ANOTHER REACH OR POND. THE OUTFLOW OF EACH REACH IS DETERMINED BY A HYDROGRAPH ROUTING CALCULATION.

POND: A POND, SWAMP, DAM, OR OTHER IMPOUNDMENT THAT FILLS WITH WATER FROM ONE OR WORE SOURCES AND EMPTIES IN A MANNER DETERMINED BY A WER, CULVERT, OR OTHER DEVCE(S) AT ITS OUTLET. THE OUTHOW(S) OF EACH POND IS DETERMINED BY A HYDROGRAPH ROUTING CALCULATION. THE PRIMARY AND/OR SECONDARY OUTFLOW WAY DRAIN INTO A REACH OR INTO ANOTHER POND.

LINK: A METHOD OF INTERCONNECTING SEVERAL HYDROGRAPHS WHICH MAY CONVERGE TOGETHER AT A COMMON ANALYSIS POINT.

The Dubay Group, Inc. 84 Range Road Windham, MH 03087 603-458-6462 Engineers Planners Surveyors TheDubayGroup.com				
20 0 10 20 1 INCH - 20 FEET				
REVISIONS: REV: DATE: COMMENT: BY:				
DRAWN BY: JHD CHECKED BY: JCM DATE: 4/29/2019 SCALE: 1"=20"				
FILE: 337 - POST DEVELOP DEED REF: BK 8043 PC 1999 BK 9135 PG 2081 PROJECT: FAMILY DENTAL CARE OF MILFORD 150 & 154 ELM STREET MILFORD, NH 03055				
FOR WILSKY INVESTMENTS, LLC. 154 ELM STREET MILFORD, NH 03055 SHEET TITLE: POST-DEVELOPMENT				
PROJECT #337 SHEET 15 of 15				

ADDITION & RENOVATION TO FAMILY DENTAL CARE OF MILFORD 154 ELM STREET, MILFORD, NH 03055

DESIGNER OF RECORD:

ARCHITECTURAL: ROBERT WILLIAM HANNON ARCHITECT PLLC 12 LANSING DRIVE, SALEM, NH

CIVIL ENGINEERING THE DUBAY GROUP, INC 84 RANGE ROAD, WINDHAM, NH

STRUCTURAL ENGINEERING: HAMPSTEAD CONSULTANTS INC 10 BRICKETTS MILL ROAD, HAMPSTEAD, NH


MECHANICAL & PLUMBING ENGINEERING: FOR DESIGN DAY MECHANICALS INC 148 BEAVER RIDGE ROAD, CENTER BARNSTEAD, NH

ELECTRICAL ENGINEERING:

ELECTRICAL SYSTEMS ENGINEERING, INC. 22 MANCHESTER ROAD, SUITE 8-A, DERRY, NH

SCHEMATIC DESIGN PROGRESS SUBMITTAL MARCH 26, 2018

DRAWIN	NG SHEET INDEX:
A001	COVER SHEET NOTES, LEGENDS, & SPECIFICA CODE PLAN & ANALYSIS
D101	DEMOLITION PLANS
S100 S101 S102 S200	GENERAL NOTES FOUNDATION PLAN FIRST AND ROOF FRAMING PLA DECK FRAMING PLANS DETAILS DETAILS
A102 A201 A301 A401 A402 A501 A601 A602 A701 A801 A802	MAIN LEVEL FLOOR PLAN LOWER LEVEL FLOOR PLAN REFLECTED CEILING PLANS ROOF PLAN & DETAILS ENLARGED TOILET PLANS STAIR PLANS & SECTION EXTERIOR ELEVATIONS BUILDING SECTIONS WALL SECTIONS & DETAILS PLAN DETAILS DOOR & WINDOW SCHEDULES DOOR & WINDOW DETAILS MISCELLANEOUS DETAILS
M-2	HVAC DUCTWORK SCHEDULES AND DETAILS SPECIFICATIONS
ES1 E1 E2 E3 E4 E5	ELECTRICAL SITE PLAN, RISER SPECIFICATIONS, LEGEND & NO FLOOR PLANS – LIGHTING, LIGH FLOOR PLANS – POWER FIRE ALARM SYSTEM FIRE ALARM SPECIFICATION
P-2 P-3 P-4	FIRST FLOOR SANITARY AND VE FIRST FLOOR DOMESTIC WATER BASEMENT SANITARY& DOMEST PLUMBING DETAILS, LEGENDS & PLUMBING SPECIFICATIONS

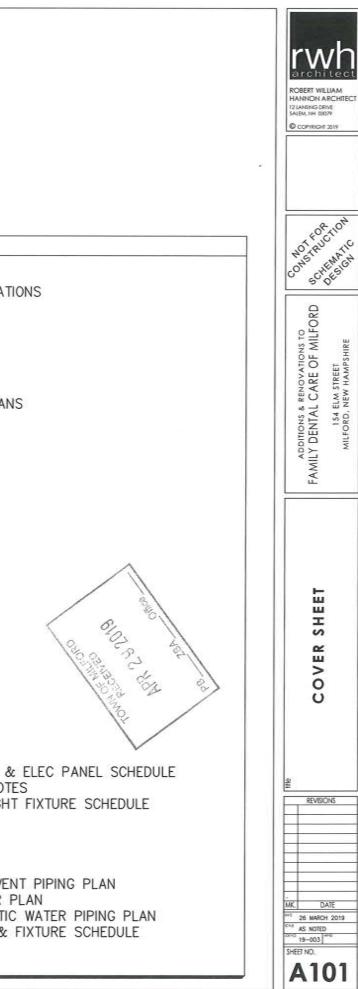

WORK NOTES

- ALL INTERIOR WALLS LACKING A PARTITION TAG TO BE PARTITION TYPE 1A, %" GYPSUM BOARD ON 2x4 WOOD
- STUDS © 15" ON CENTER WITH ACOUSTICAL BATT INSULATION. PROVIDE MOISTURE RESISTANT GYPSUM BOARD IN TOLET ROOMS AND ANY OTHER WET LOCATIONS WHERE NOT

- PROVIDE UNISTURE RESISTANT CHPSUN BOARD IN TOLET ROOMS AND ANY OTHER NET LOCATIONS WHERE NOT SPECIFIC LISEMMERE. USE COMENT BOARD AT ALL LOCATIONS OF CERANIC TILE OR SIMILAR MATERIAL. PROVIDE SOLD WOOD BLOOKING BEHIND ALL NALL-MOUNTED ITEMS LOCATE HINGE SILE OF DOORS 4 NICHES FROM MODE CORNER, THYICAL UNLESS OTHERWISE NOTED. PROVIDE CORNER BEADS AT ALL SYNSIM BOARD OUTSIDE TRANSITIONS AND 'J BEADS AT ALL TRANSITIONS TO DISSIMULAR MATERIALS. PROVIDE CORNER BEADS AT ALL SYNSIM BOARD OUTSIDE TRANSITIONS AND 'J BEADS AT ALL TRANSITIONS TO DISSIMULAR MATERIALS. PROVIDE CORNER BEADS AT ALL SYNSIM BOARD OUTSIDE TRANSITIONS AND 'J BEADS AT ALL TRANSITIONS TO DISSIMULAR MATERIALS. PROVIDE SUBJECT SILLS AT ALL WINDOWS. REFER TO WINDOW DETALS. PROVIDE SUBJECT SILLS AT ALL WINDOWS. REFER TO WINDOW DETALS. PROVIDE SUBJECT SILLS AT ALL WINDOWS. ALL INTERIOR GLAZING SHALLS AS INDICATED ON DESIGN FROMVONICS INTERIOR DESIGN PACKAGE. ALL WITEMOR GLAZING SHALL BE CLEAR THERPERD SAFETY GLASS. I. PROVIDE TRANSITION STRIPS BETWEEN ALL DISSIMULAR FLOORING MATERIALS. FLOORING TRANSITIONS AT DOORS ARE TO OCCUE DIRECTLY BELOW COENTER OF DOOR PANEL IN CLOSED POSITION. CHANGES IN FLOOR FINISH MATERIALS SHALL HAVE AN EDOE STRIP OR THRESHOLD THAT IS ERVILED AT A RATIO OF OUCE. AND SHALL DIS SHALL ON EDUCED IN IN HEIDIT AND SHALL BE POSITION. CHANGES IN FLOOR FINISH MATERIALS SHALL HAVE AN EDOE STRIP OR THRESHOLD THAT IS ERVILED AT A RATIO OF OUCE. AND SHALL NOT EXCEED IN IN HEIDIT AND SHALL DE VERIED ON BEINGES INFLOOR SHOLES INFLOOR TRANSITIONS AT DOORS ARE TO OCCES SHALL NOT EXCEED IN IN HEIDIT AND SHALL DE VERIED ON BEINGES INFLOOR STRIP. 12. THRESHOLDS SHALL NOT EXCEED ½ INCH IN HEIGHT AND SHALL BE BEVELED ON BOTH SIDES WITH A SLOPE NO
- Included and the Decemption of the

- ACLESSELE AND TACILLE SIGNAGE, WITH PROTOKAN WERKE REQUIRED, STALL BE PROVIDED AT ACL DUDKS. INSTALL SIGNAGE ON THE LATCH SIG OF THE DOOK AT 60 INVESTS ABOVE FINISH FLOOR TO HORIZONTAL CENTER OF SIGN.
 HOOR HANDLES MUST BE LEVER TYPE TO COMPLY WITH ACCESSIBILITY REQUIREMENTS.
 CELINOS SHALL MOT BE INSTALLED LESS THAN 7'-6' ABOVE FINISH FLOOR.
 INSTALL LULIMINATE DE LINT SIONS ABOVE DOORS LEVENNS TO THE EXTERIOR AND USED AS A MEANS OF EGRESS.
 PROVIDE A MINIMUM OF THIS FINIS ABOVE DOORS LEVENSTO THE EXTERIOR AND USED AS A MEANS OF EGRESS.
 INSTALL ALL PRODUCTS AD WITHOUT DO BE CONCRALED WITHIN WALLS UNLESS SPECIFICALLY DENTIFIED AS EXPOSED ON AROHTECTURAL DRAININGS.
 INSTALL ALL PRODUCTS PER MANUFACTURER'S RECOMMENDATIONS. IF DISCREPANCY OCCURS BETWEEN THIS SET OF DRAININGS AND THE MANUFACTURER'S RECOMMENDATIONS, IF DISCREPANCY OCCURS BETWEEN THIS SET OF DRAININGS AND THE MANUFACTURER'S RECOMMENDATIONS, IF DISCREPANCY OCCURS BETWEEN THIS SET OF DRAININGS AND THE MANUFACTURER'S RECOMMENDATIONS, PAUSE WORK AND REQUEST CLARFICATION FROM ARCHITECT.
 ONSTALL ALL PRODUCTS PER MANUFACTURER'S RECOMMENDATIONS, PAUSE WORK AND REQUEST CLARFICATION FROM ARCHITECT.
 ONSTALL ARCHITECT IN-PIELD FOR ANY DETAILS NOT INCLUDED WITHIN THIS DRAINES SET. DO NOT PROCEED WITH CONSTRUCTION OF ANY LEVENT THAT IS NOT SHOUND WITHOUT WITTEN APPROVING. FOR THE ARCHITECT.
 PROVIDE GERSUM DARD CONTROL, LONGTS IN ACCORDANCE WITH PROVIDED ANTERCURER RECOMMENDATIONS.
 CONSTRUCTION OF ANY LEVENT THAT IS NOT SHOUND WITHOUT WRITTEN APPROVING. FOR RECOMMENDATIONS.
 CONSTRUCTION OF ANY LEVENT THAT IS NOT SHOUND WITHOUT WRITTEN APPROVING. FOR THE ARCHMEDT.
 CONSTRUCTION OF ANY LEVENT THAT ROOM, UNLESS NOTED OTHERWISE.
 ALL DURED CONTROL, LONGTS MESTING ARE ON OTHER OLITIS IN ACCOUNT ANTERVERTING RECOMMENDATIONS.
 ALL AND HERE AND FROM FROM FROM FROM FROM THOOT THARTER ARCOMM


GENERAL NOTES

- ALL CONSTRUCTION/WORK SHALL COMPLY WITH ALL APPLICABLE BUILDING CODES, STANDARDS, & ORDINANCES.
 REFER TO DRAWING A002 & A003 FOR CODE AND EGRESS REQUIREMENTS.
 REFER TO TITLE SHEET & REVISION BLOOK FOR REASON AND DATE OF PLOT. DRAWINGS NOTED AS "FR" ARE ISSUED FOR REVIEW ONLY. DRAWINGS NOTED AS "FR" ARE ISSUED FOR FEMIT ONLY. ONLY DRAWINGS NOTED AS "FC" AND INCLUDE A SIGNED AND SEALED STAMP ARE ISSUED FOR FEMIT ONLY. ONLY DRAWINGS NOTED AS "FC" AND INCLUDE A SIGNED AND SEALED STAMP ARE ISSUED FOR CONSTRUCTION. IT IS THE SOLE RESPONSIBILITY OF THE CONTRACTOR TO ASSURE THAT DRAWINGS NOTED AS "FR" AND LECTROCI. AND PLUMBING DRAWINGS.
 CONTRACTOR TO COMPLY TO AND AND ASSURE THAT THE MOST OURPOINT.
 CONTRACTOR TO COMPLY TO AND AND ASSURE THAT DRAWINGS ONEE ARE THE MOST OURPOINT.
 CONTRACTOR TO COMPLY TO AND AND TAY AND ADDIT OF THE ADDIT ADDITIONAL ONLY MECHANICAL, ELECTROCI. AND PLUMBING DRAWINGS.
 CONTRACTOR TO COMPLY TO AND ANT 72000 FOR ACCESSEDUITY INFORMATION AND REQUIREMENTS.
 CONTRACTOR TO COMPLY TO AND AND AND ADDIT OF THE ADDITIONAL ONLY BOUND AND ADDITIONAL AND PLUMBING DRAWINGS.

- 6. CONTRACTOR SHALL BE RESPONSIBLE FOR PROVIDING ALL MATERIALS (UNLESS NOTED OTHERWISE), AND WORKMANSHIP IN ACCORDANCE WITH FEDERAL, STATE, CITY AND LOCAL BUILDING CODES AND THEIR
- 6. CONTRACTOR SPACE DE RESPONSIBLE PORTROLLING ALL MATERIALS (DIRESS NOTED OTRESS), AND WORKMASHP IN ACCORDANCE WITH FEDERAL, STATE, CITY AND LOCAL BUILDING CODES AND THEIR RECURRIMENTS.
 CEDERAL CONTRACTOR TO PROVIDE SUBJITTALS AND SHOP DRAWINGS TO ARCHTECT FOR APPROVAL PRIOR TO ONDERING OF MATERIALS, FABRICATION, OR INCORPORATION INTO THE CONSTRUCTION.
 CEDERAL CONTRACTOR TO PROVIDE SUBJITTALS AND SHOP DRAWINGS TO ARCHTECT FOR APPROVAL PRIOR TO ONDERING OF MATERIALS, FABRICATION, OR INCORPORATION INTO THE CONSTRUCTION.
 CEDERAL CONTRACTOR TO PROVIDE AUTULALS AND SHOP DRAWINGS TO ARCHTECT FOR REVEW AND APPROVAL PRIOR TO CONSTRUCTION.
 FIELD VENEY ALL DIREVISIONS AND LAYOUT PRIOR TO PROCEEDING WITH WORK. NOTFY ARCHTECT IN WRITING OF ANY DISCREPANCES OR NUCONSISTENCES.
 10. CONTRACTOR AND ALL TRACES SHALL NOTE REQUIREMENTS OF "GENERAL NOTES" ON ALL SHEETS.
 11. DIMENSIONS ANDE FACE OF CONCRETE, FACE OF MASONRY, AND FACE OF STUDS, UNLESS NUCLATED OTHERWISE.
 12. DIMENSIONS NOTED 'LEAR' OR "NUMMUN" IS TAKEN TO FACE OF FINISHED SUBFACE.
 13. NOTEY ARCHTECT IF '* DIMENSIONS WARY BY MORE THAN 1 INCH.
 14. RELATIONSHIP OF OBJECTS GRAPHICALLY SHOWN TO BE 'CENTERED' ARE ASSUMED TO BE CENTERED, UNLESS OTHERWES, OTHERWISE, OFHERMISE, MARCHTER, AND ASSUMED TO BE CENTERED, UNLESS OTHERWED, UNLESS OTHERWES, OTHERWISE, OTHER DETAILS, TO ALL CONSTRUCTION DOCUMENTS FOR REQUIREMENTS WHICH MAY AFFECT THE WORK IN ANOTHER DISCIPLINE AND COORDINATE WORK.

- DISCIPLINE AND COORDINATE WORK.
 16. REFER TO DETAILS FOR ADDITIONAL DIMENSIONAL INFORMATION.
 17. DO NOT SCALE DRAWINGS.
 18. "PROVIDE" MEANS "FURNISH AND INSTALL".


- 16. FNORME MEMOS FORMER AND INSTALL. 19. ALL FURNITURE, EOLIPHICA, & APPLIANCES TO BE PROVIDED BY OTHERS. 20. THE CONTRACTOR SHALL KEEP, ON THE WORK SITE, A COPY OF THE CONTRACT DRAWINGS, DRAWINGS ARE TO MAINTAINED AND MARKED PER PIELD CHANCES SUCH THAT THE SET WILL BECOME AN AS-BUILT SET FOR ISSUE TO THE DIMMER AT THE CLOSE OF THE PROJECT.
- 21. AN AIR & VAPOR BARRER (BUILDING THERMAL ENVELOPE) PRE-CONSTRUCTION MEETING WITH THE ARCHITECT IS

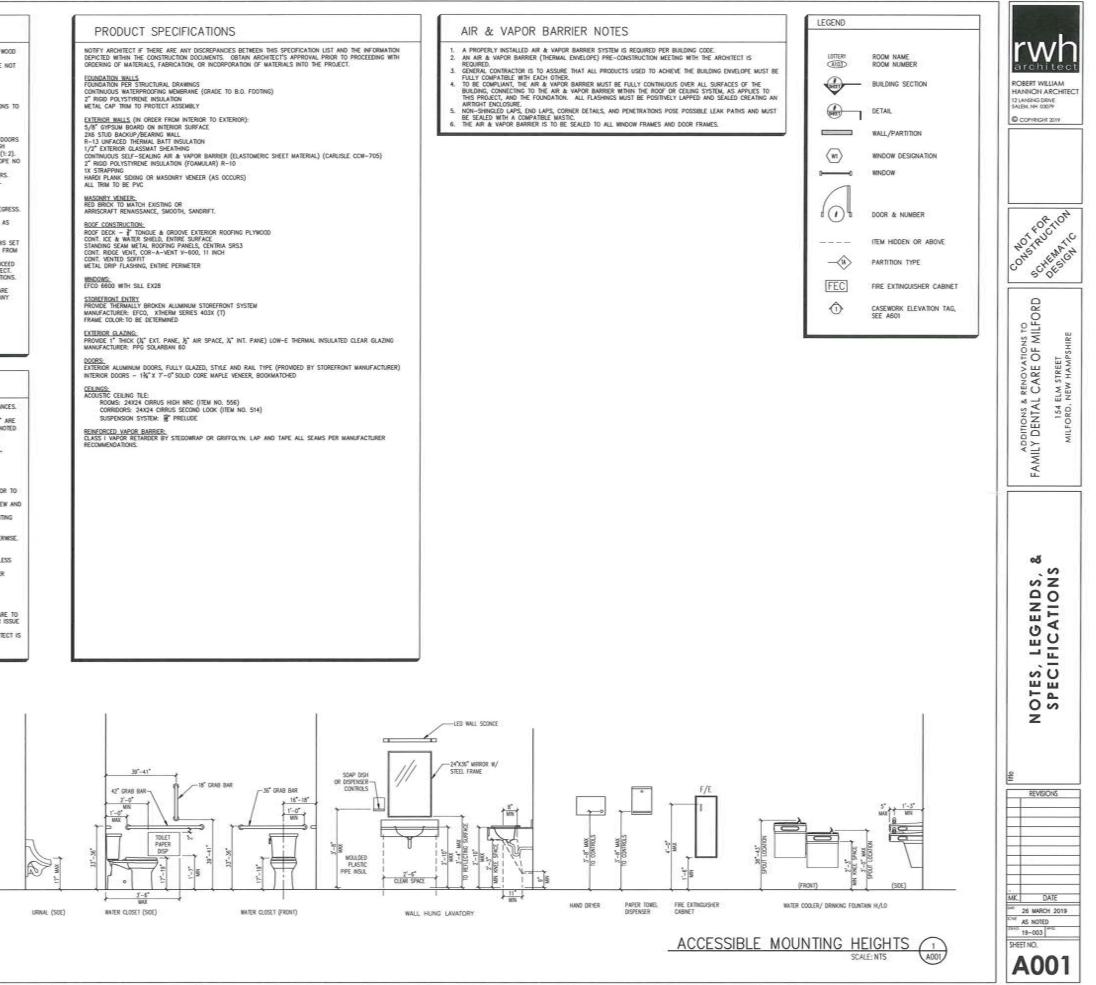



PPICABLE CODES & STANDARDS:	IBC CHAPTER 13 - ENERGY EFFICIENCY:				
NEW HAMPSHIRE STATE BUILDING CODE INTERNATIONAL BUILDING CODE 2009 (IBC)	CLIMATE ZONE 5A (HILLSBOROUGH COUNTY)				
NATIONAL FIRE PROTECTION ASSOCIATION (NFPA) 101 LIFE SAFETY CODE (2015)	ROOF:				
ACCESSIBLE AND USABLE BUILDINGS AND FACILITIES ICC A117.1-2009	INSUL ABOVE DECK = R-20ci ATTIC = R-38				
BC CHAPTER 3 - USE AND OCCUPANCY CLASSIFICATION: ROUP B EDUCATION (IBC 304.1, CLINIC OUTPATIENT)	$\begin{array}{llllllllllllllllllllllllllllllllllll$				
BC CHAPTER 5 - GENERAL BUILDING HEIGHTS:	BELOW GRADE: = R-7.5Cl				
YPE: VB CONSTRUCTION TYPE (IBC SECTION 503)	$\frac{FLOOR:}{JOIST FRAMING} = R - 30$				
CONSTRUCTION TYPE: YPE VB — UNPROTECTED ION-SPRINKLERED ABULATED ALLOWABLE AREA PER STORY: 9,000 SF CIUAL AREA PER STORY: 8,186 SF RUILDING AREA MODIFICATION: 15,750 SF ILLOWABLE STORIES: 2 (40") ICTUAL STORIES: 1 W/BASEMENT	<u>SLAB ON GRADE:</u> UNHEATED SLAB = N/A HEATED SLAB = R-15 FOR 24" BELOW				
BC CHAPTER 6 - TYPES OF CONSTRUCTION:					
BC TABLE 601 FIRE RESISTANCE RATING REQUIREMENTS FOR WILDING ELEMENTS					
IRE RESISTANCE RATING REQUIREMENTS FOR BUILDING CLEMENTS, TYPE VB: RIMARY STRUCTURAL FRAME: (0) HR RATING IEARING WALLS(INTERIOR): (0) HR RATING IEARING WALLS(EXTERIOR): (0) HR RATING IONBEARING WALLS: (0) HR RATING LOOR CONSTRUCTION: (0) HR RATING IOOF CONSTRUCTION: (0) HR RATING					
BC CHAPTER 8 - INTERIOR FINISHES:	LEGEND				
BC TABLE 803.9 XIT ENCLOSURES & EXIT PASSAGEWAY: CLASS A	FIRE EXTINGUISHER CABINET:				
CORRIDORS: CLASS B	EXIT SIGN: @				
ROOM & ENCLOSED SPACES: CLASS C	TRAVEL DISTANCE:				
BC CHAPTER 9 - FIRE PROTECTION SYSTEMS:	COMMON PATH: ACCESSIBLE EGRESS:				
903.2):AUTO SPRINKLER SYSTEM NOT REQUIRED AS LESS HAN 4 OCCUPANTS ARE INCAPABLE OF SELF-PRESERVATION.					
906.3) MAX TRAVEL DISTANCE TO FIRE EXTINGUISHER IS 75' IR REQUIRED BY FIRE CODE OFFICIAL					
BC CHAPTER 10 - MEANS OF EGRESS:					
IUSINESS AREAS = 100 GROSS SF/PERSON OTAL OCCUPANT LOAD: 163 PERSONS					
APACITY FACTORS (IBC TABLE 7.3.3.1) TAIRWAYS: 0.3 INCHES PER PERSON EVEL COMPONENTS & RAMPS: 0.2 INCHES PER PERSON					
$\begin{array}{llllllllllllllllllllllllllllllllllll$					


IBC CHAPTER 29 - PLUMBING FIXTURE REQUIREMENTS; (IBC TABLE 2902.1 MIN. NUMBER OF REQUIRED PLUMBING FIXTURES)


OCCUPANCY	WATER CLOSETS		LAVATORIES		DRINKING	070/50	
	MALE	FEMALE	MALE	FEMALE	FOUNTAINS	OTHER	
BUSINESS	1 PER 25 FOR THE FIRST 50, 1 PER 50 FOR THE REMAINDER EXCEEDING 50		1 PER 40 FOR THE FIRST 80, 1 PER 80 FOR THE REMAINDER EXCEEDING 80		1 PER 100	1 SERVICE SINK	
REQUIRED:	3	3	3	3	2	1	

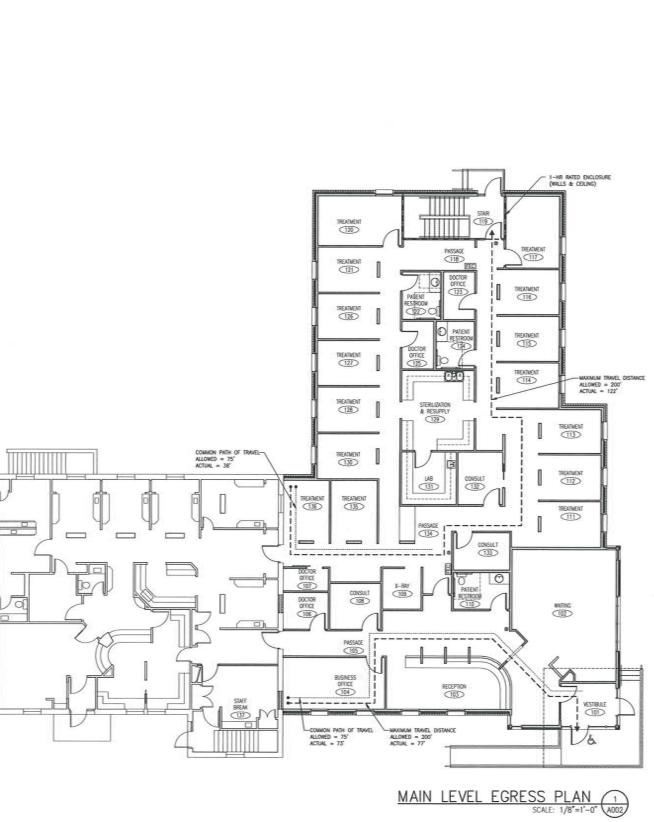

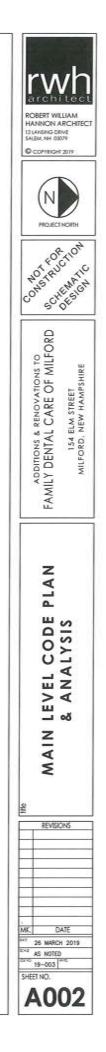


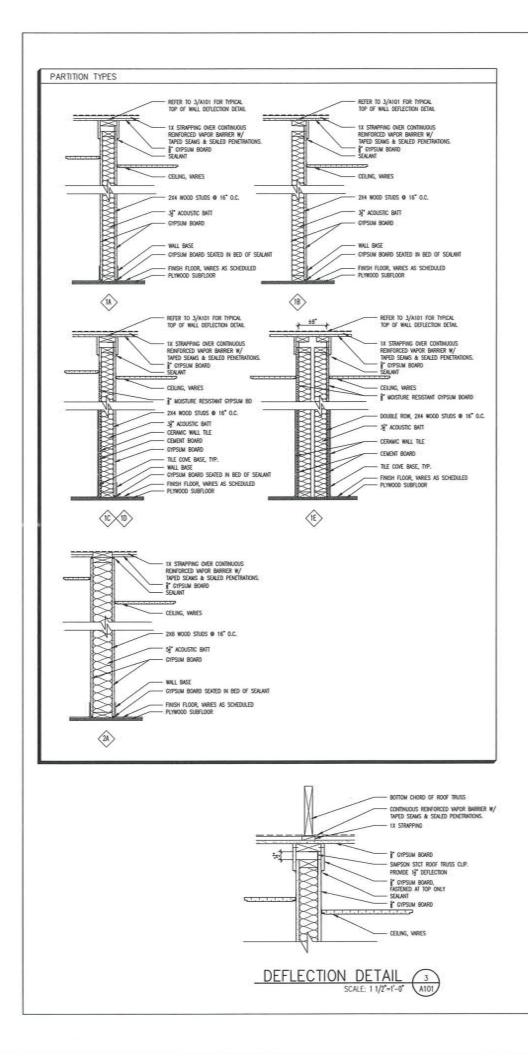


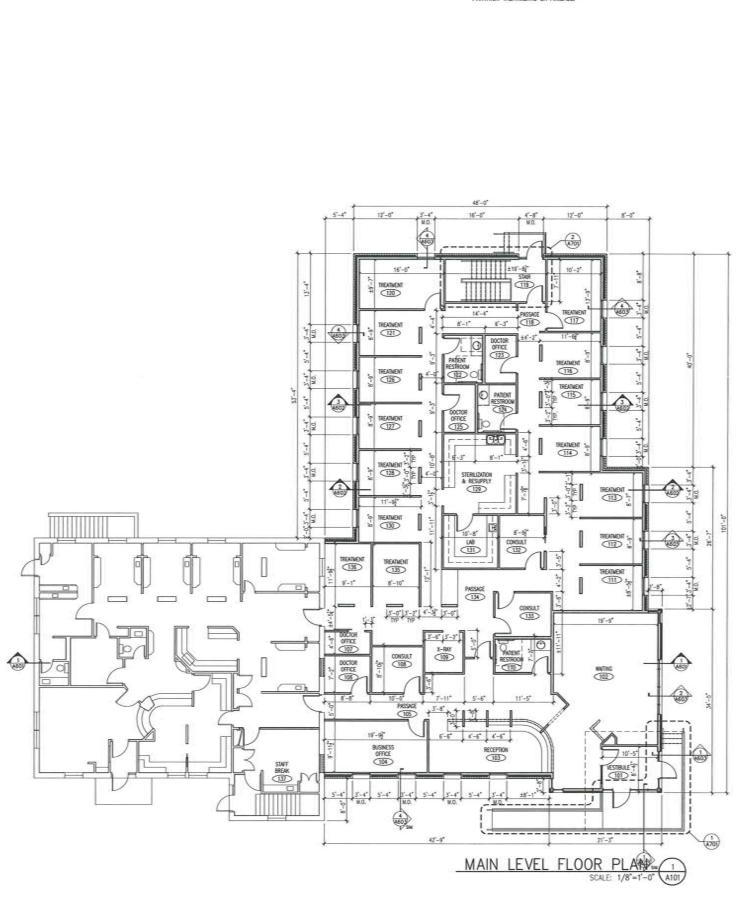


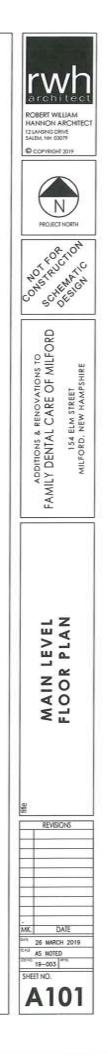



NOTE: I. ALL DIMENSIONS ARE TAKEN FROM FACE OF CONCRETE OR FACE OF STUD. WHERE CLEAR DIMENSIONS ARE NOTED, IT IS THE CONTRACTORS RESPONSIBILITY TO ACCOUNT FOR THOKNESS OF GYPSUM BOARD AND ANY PARTITION TREATMENTS OR FINISHES.

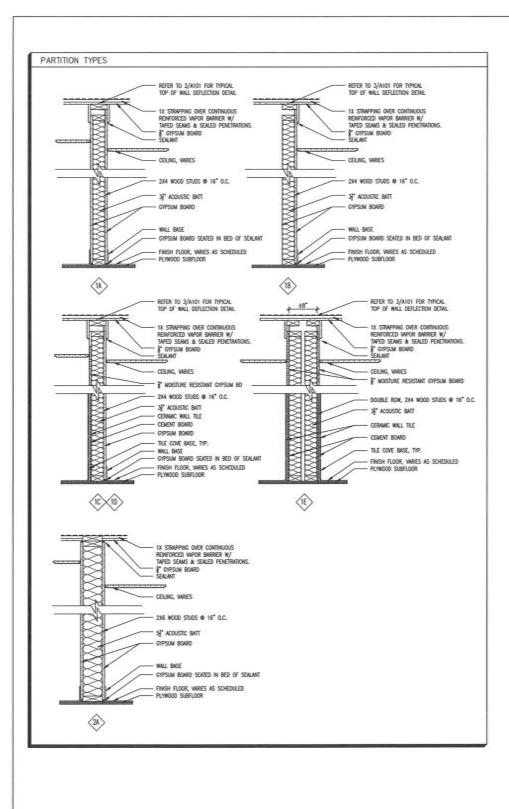


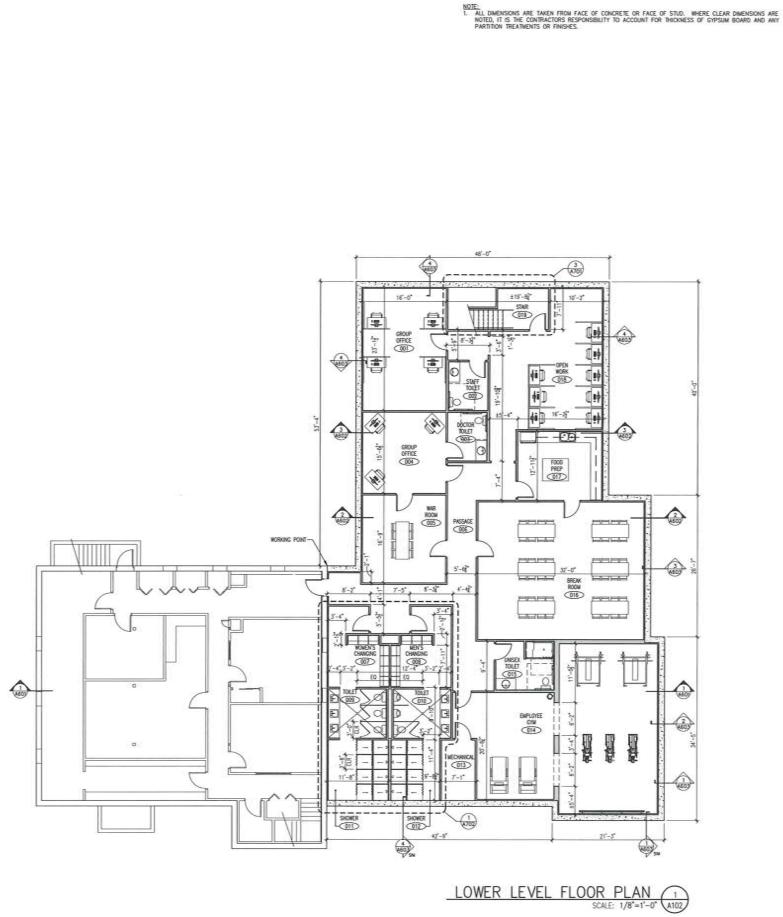


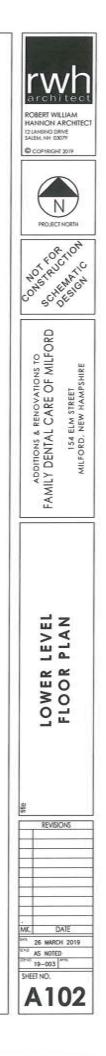


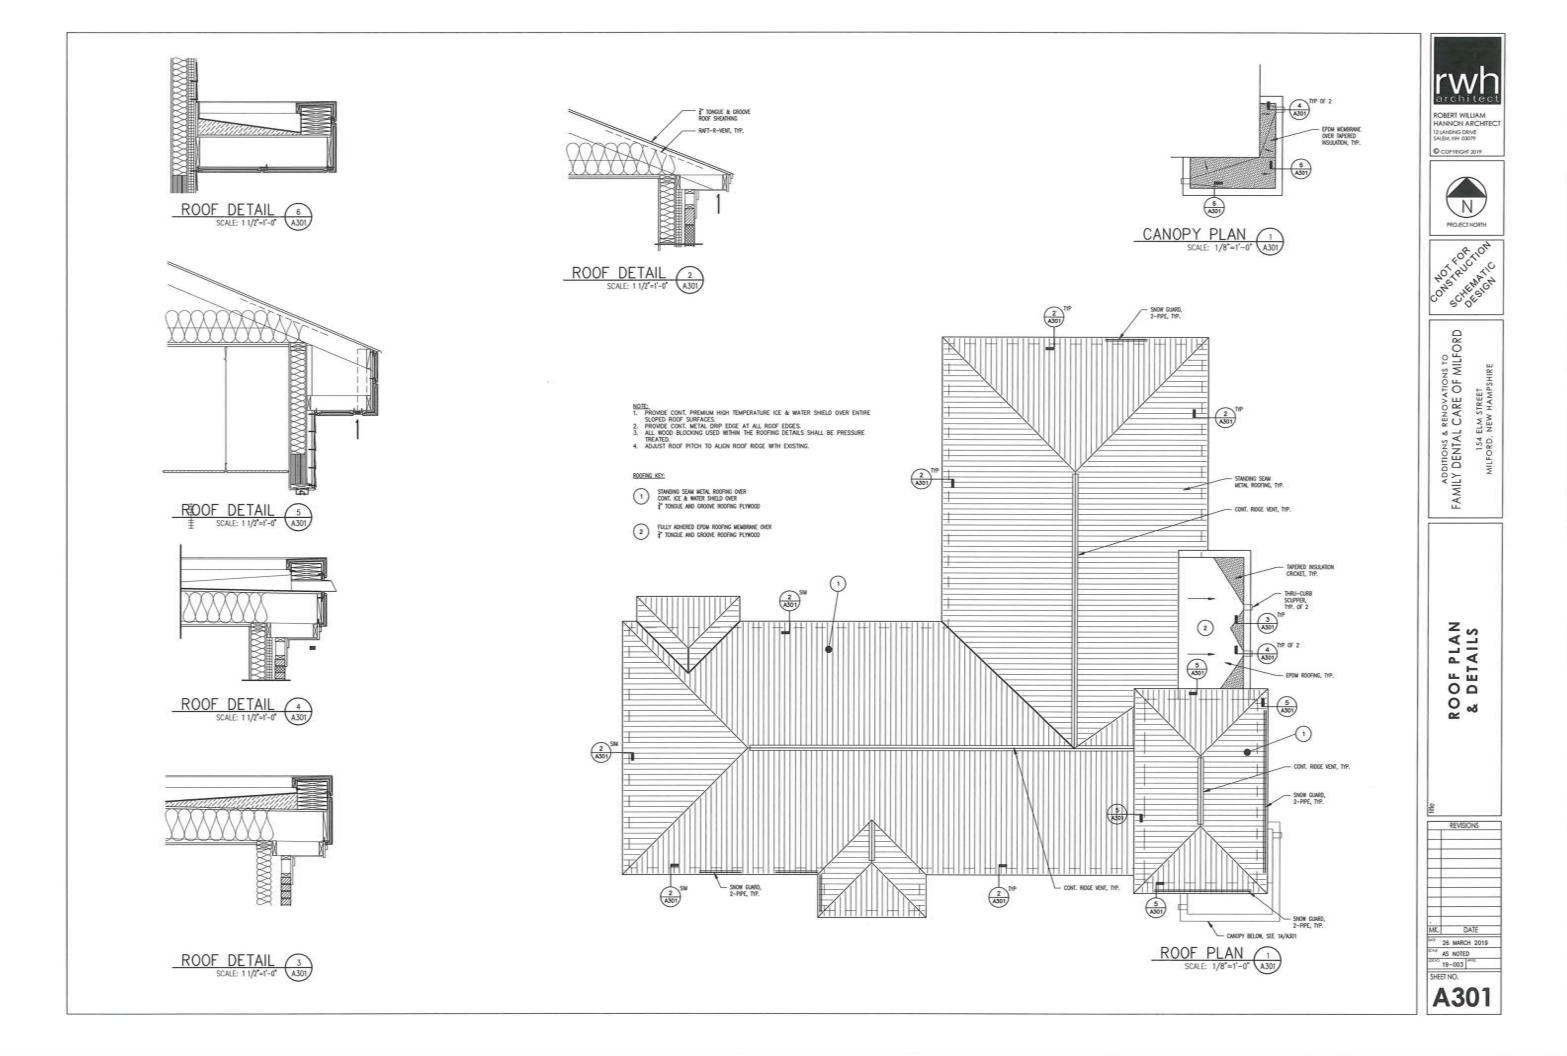

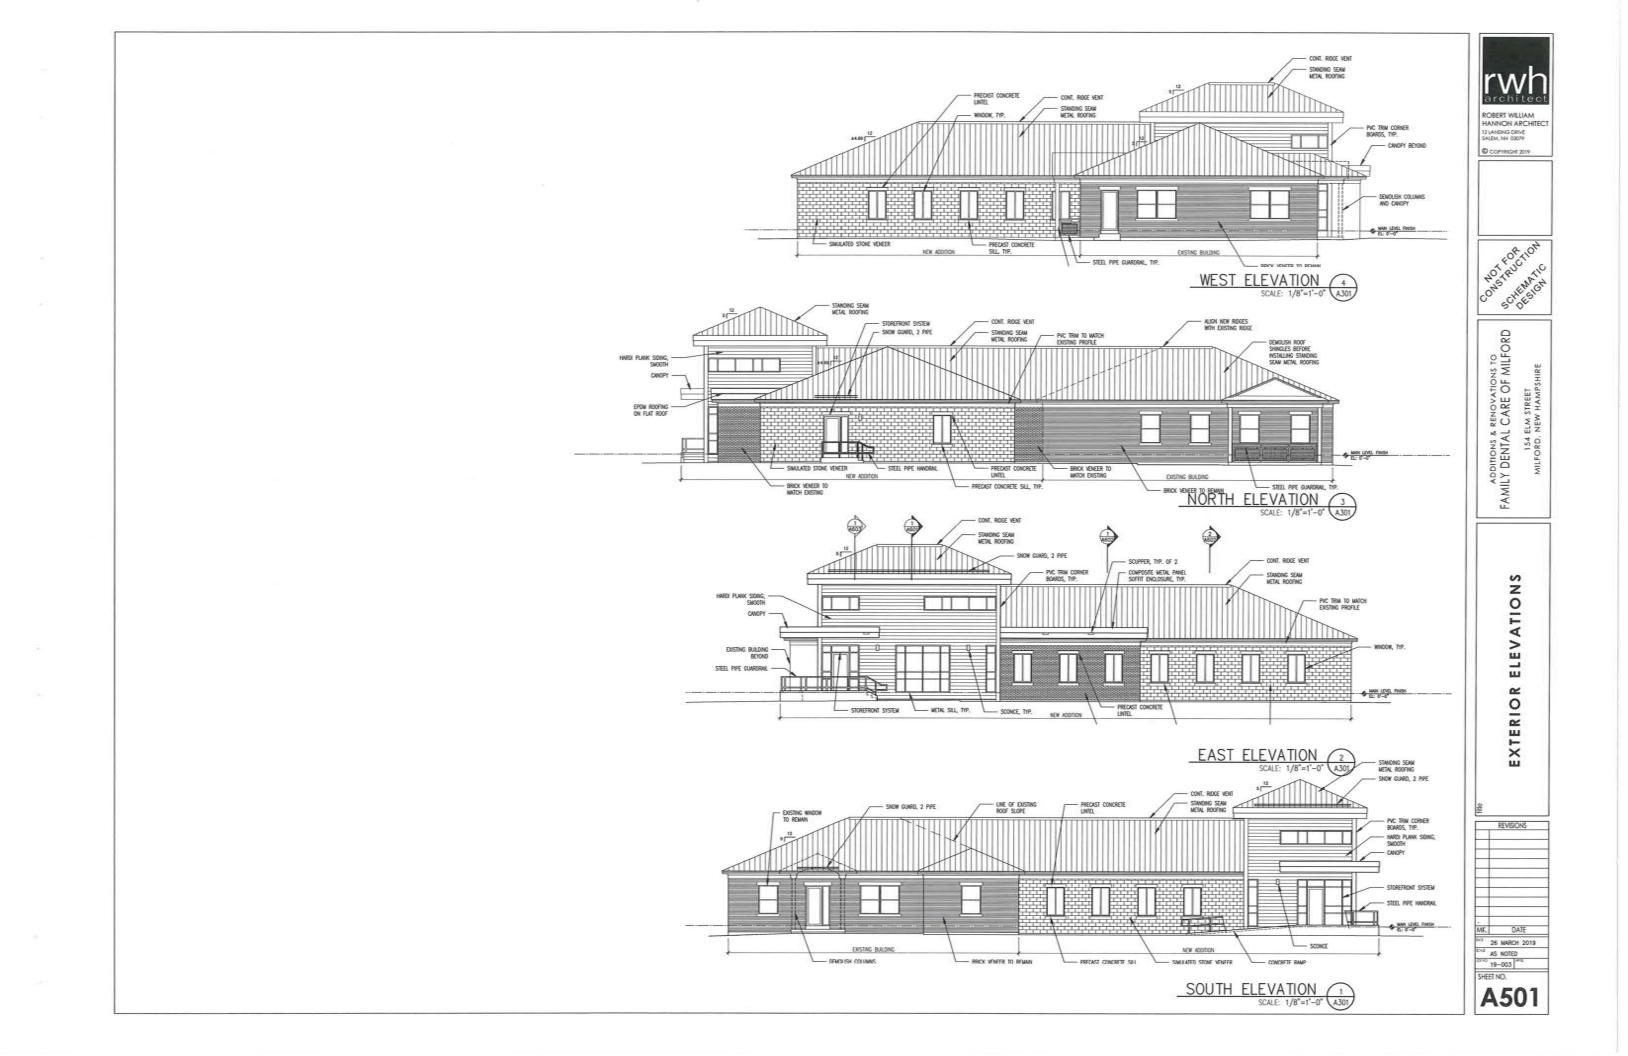

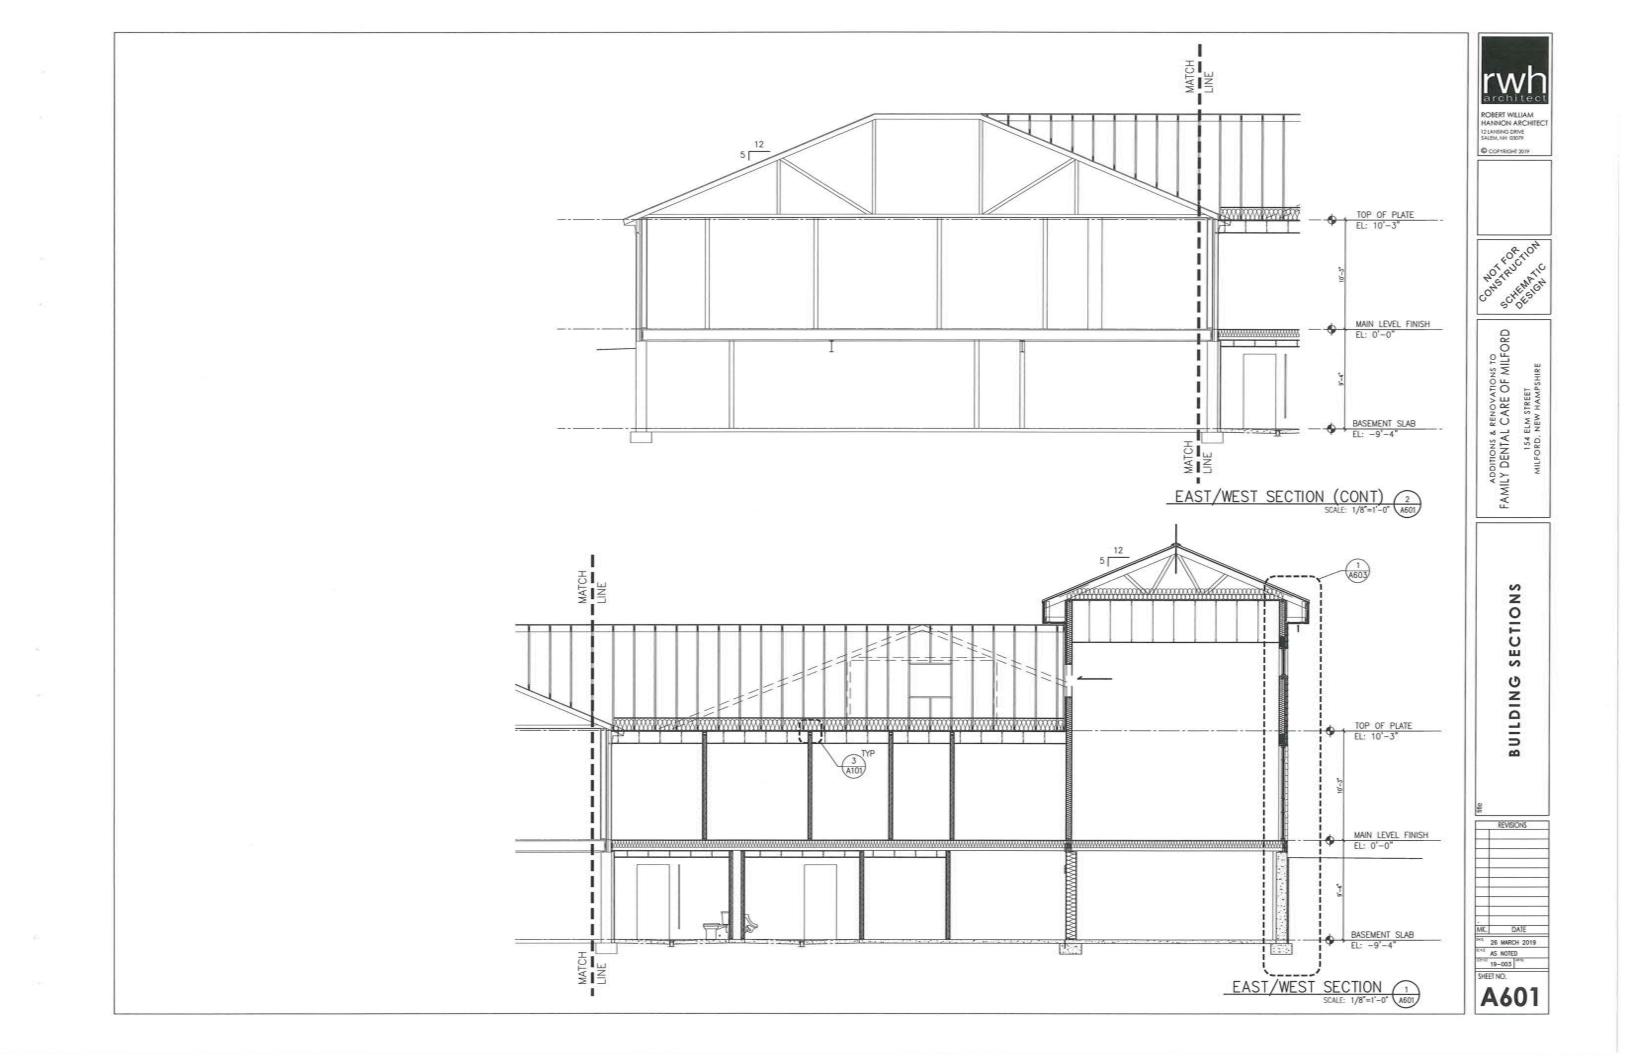

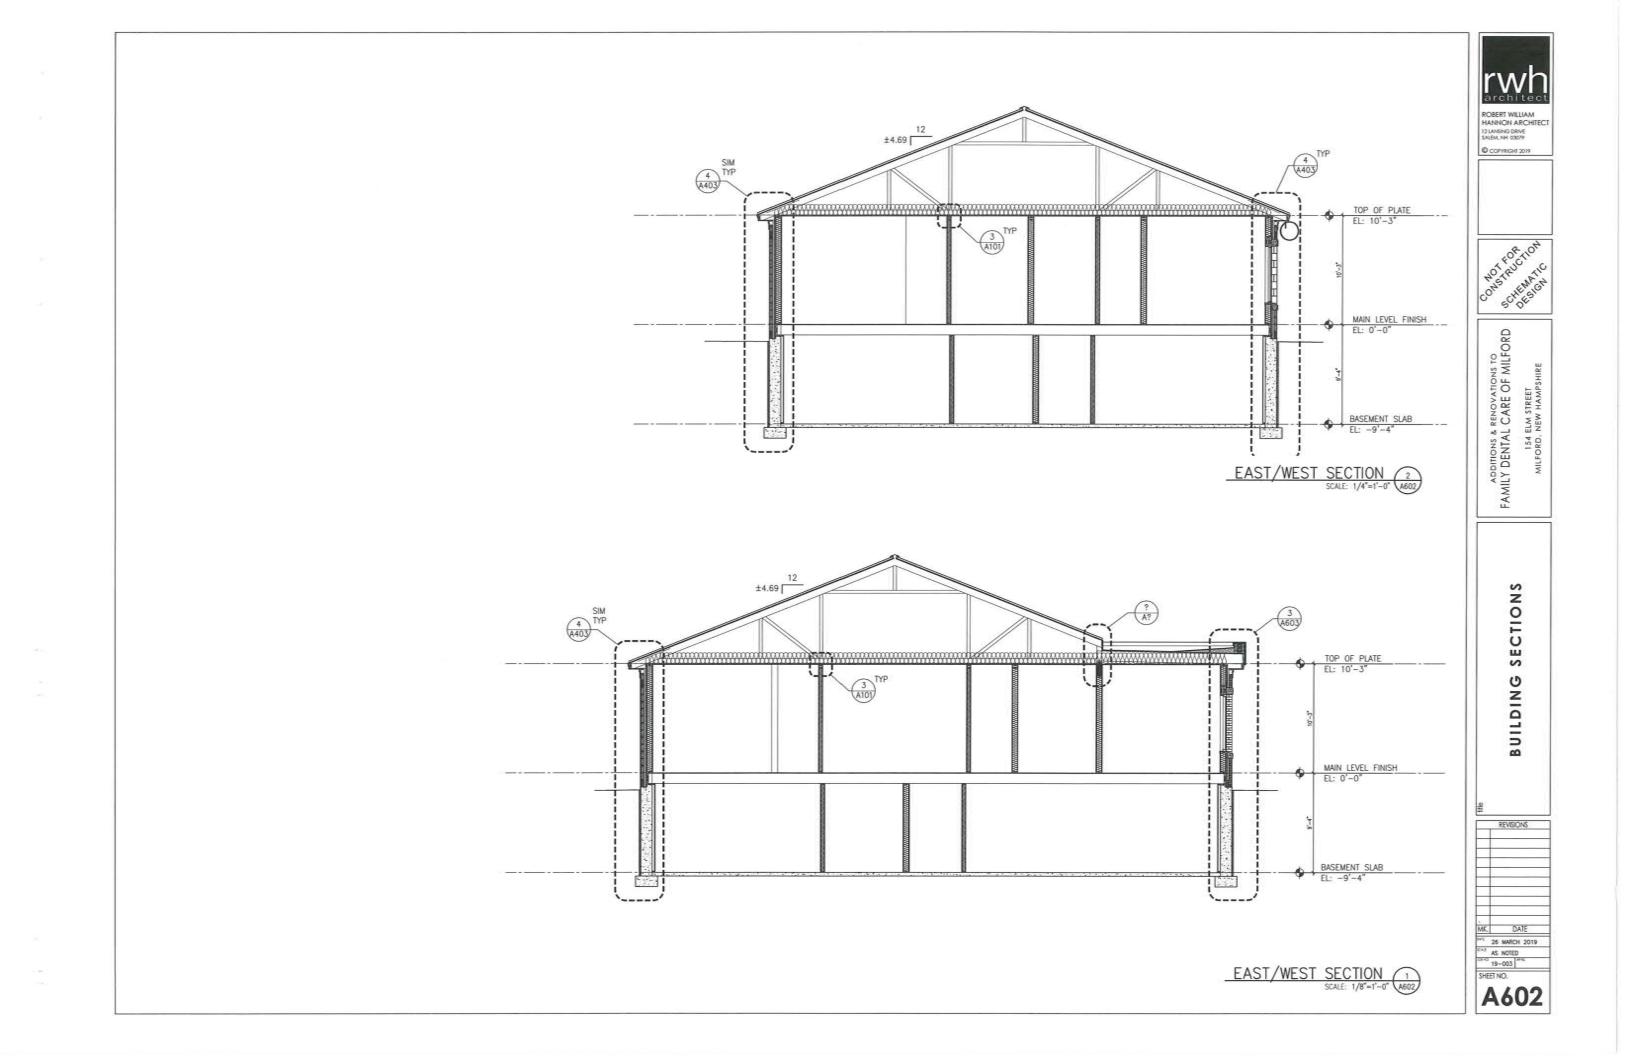

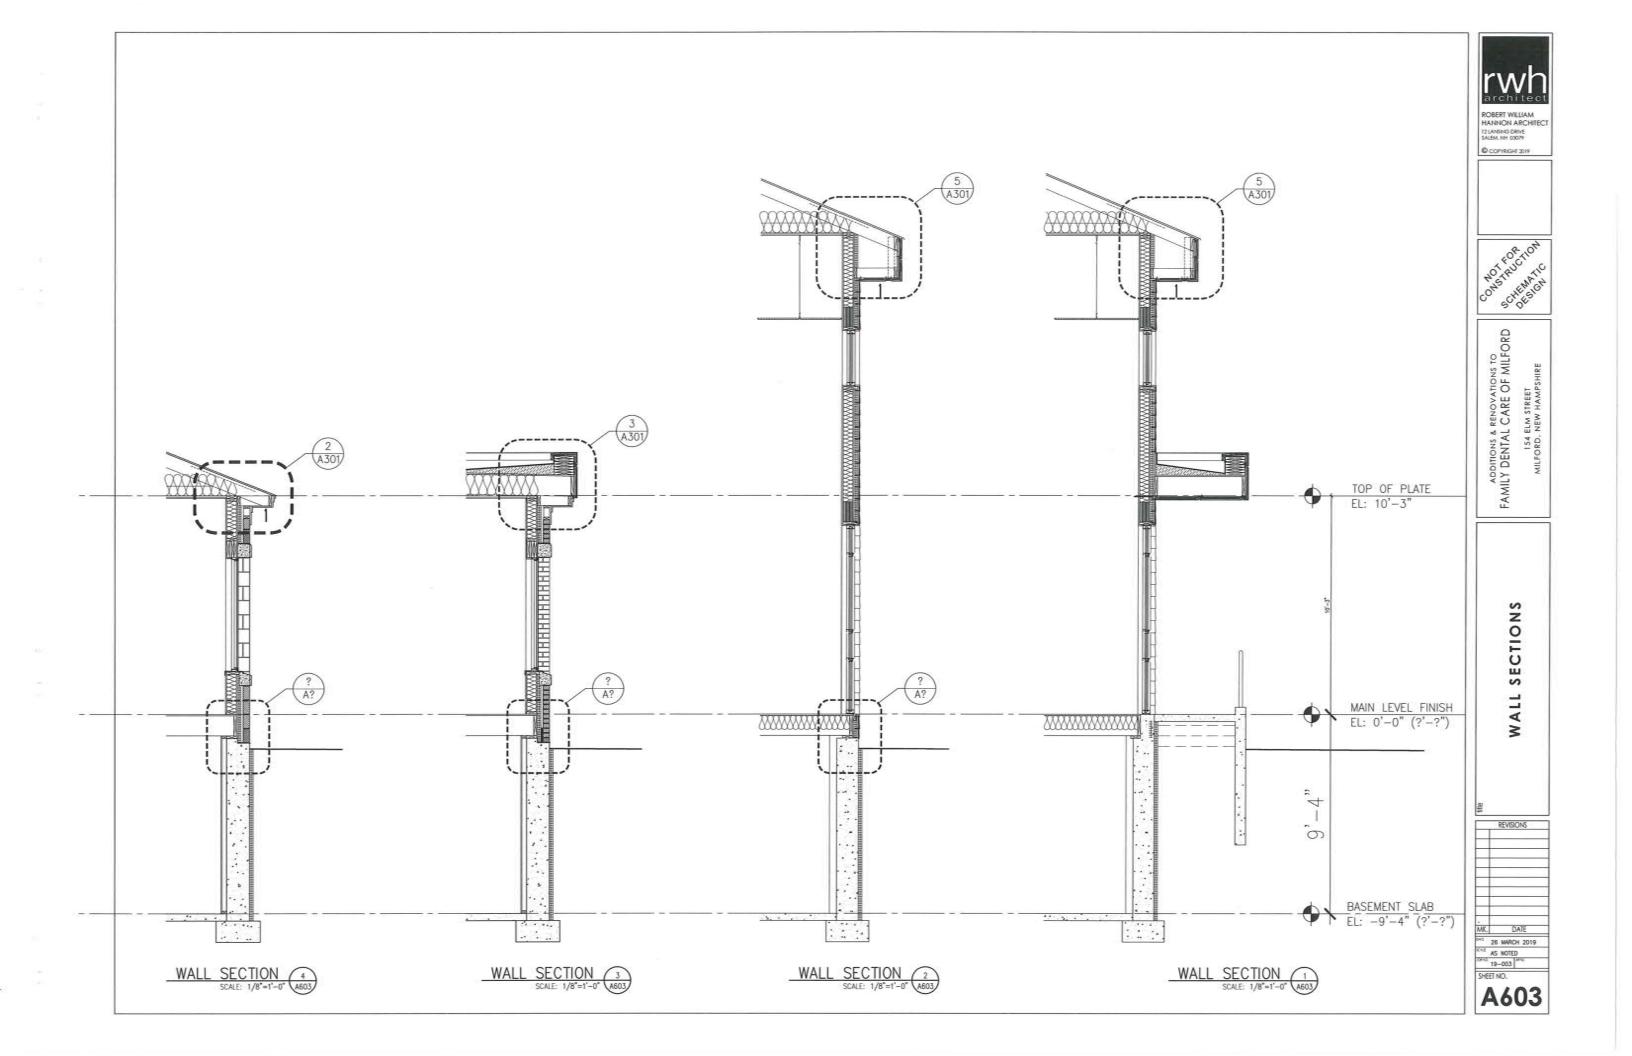



Waiver Request Form

Department of Planning and Community Development

Name of Project _

Family Dental Care of Milford

Applicant Family Dental Care of Milford

Date April 29, 2019

planning office, and that the waiver request will be considered at the meeting. indicate that a waiver request has been received, a copy of which is available at the meeting. The Board's publicly notice agenda for the particular meeting shall clearly the waiver is needed by the application deadline for a regularly scheduled Planning Board pertain to the subdivision or site plan. The applicant shall present reasons in writing why may request in writing to waive specific requirements of these Regulations as they When a proposed subdivision plat or site plan is submitted for approval, the applicant

Abutter notification is required for all waiver requests.

the public interest secured, provided that such waiver will not have the effect of based upon the evidence presented to it in each specific case. Master Plan. The Planning Board shall not approve waivers unless it shall make findings nullifying the intent and purposes of these Regulations, the Zoning Ordinance or the The Planning Board may grant a waiver in a special case, so that justice may be done and

general description of the waivers. All approved waivers shall be noted on the plans, indicating the paragraphs waived and a

Subdivision or Site Plan Regulation Section Number

1. 6.05.6 C.3

Request and Rationale

"L" shaped and allows existing functioning treatment rooms to share that existing building sits at rear of lot. Proposed addition layout is labs, supplies and steralization areas without duplicating space. Build-toZone - Proposed addition is 70'+/- from R.O.W.due to fact

Proposed Building is the same setback as the Auto Store next door.

Signatur	Please feel free to attach	6.	5.	4. <u>6.05.6 A.2</u>	3. <u>6.05.6 2.b</u>	Subdivision or Site Plan Regulation Section Number
$\frac{H}{2\alpha H}$	Please feel free to attach any other information as necessary.		Applicant's work with Design Ergonomics, RHW Architects and the engineer since summer 2018 has yielded a building layout that is most condusive to tenant's needs and the site layout works best to adhere to building setbacks, coverage and keeps parking to side and rear.	Development Review - Presentation on 04/23/2019 to Planning Board gave an in depth look at the preliminary design and planning to date.	Building Orientation - Orient Building Entry to Public Street Existing entrance is at rear. The addition will relocate the main entrance. Proposed building entry is at the east side and rear corner of lot. A new entry "tower" aids in visibility and way finding for pedestrian.	Request and Rationale

.

N:\Planning Department\Forms\WaiverRequestForm_060614.doc

p.2

(603) 413-6650

KVPartners LLC

P.O. Box 432, New Boston, NH 03070

May 23, 2019

Lincoln Daley, Community Development Director Town of Milford 1 Union Square Milford, NH 03055

Re: Family Dental Care of Milford, 150 & 154 Elm Street, Site Plan (Map 13, Lots 13 & 14) Drainage Review

Dear Mr. Daley:

We reviewed the 15-sheet plan set dated April 29, 2019 and Stormwater Management Report dated April 26, 2019 prepared by The Dubay Group in accordance with our agreement with the Town. As requested, our review was limited the drainage system only. Based on that review and a site visit, we offer the following comments:

- 1. The Estimated Seasonal High-Water Table and infiltration rates need to be determined by a test pit/testing in the stormwater basin particularly since infiltration is a critical element of the stormwater mitigation design, there is limited reserve capacity in the infiltration basins and overflow onto the roadway would be very undesirable.
- 2. The Rain Garden Detail (appears to be a standard detail from NH Stormwater Manual) depicts an underdrain pipe, however, this pipe is not shown on the plans and there is no place to discharge the pipe. Also, it is not clear from the plans and details what vegetation will be planted in the bottom of the Rain Garden beyond what is shown on the landscaping plans. Please clarify.
- 3. There appears to be some offsite flow from the gravel area adjacent to the southwest corner of the site that will flow into the infiltration basin. Any off-site flow that contributes to the infiltration basin must be included in the calculations.
- 4. Add a construction detail for the pond overflows that depicts shape, slope and surface materials (assume it will be grassed overflow).

If you have any questions or need any additional information, please feel free to contact me at 603-413-6650 or on my cell phone at 603-731-1562 or by email at <u>MVignale@kvpllc.com</u>.

Sincerely,

KV Partners LLC

Michael S. Vignale, P.E. Principal Engineer

Town of Milford CONSERVATION COMMISSION

Town Hall 1 Union Square Milford, NH 03055-4240 (603) 249-0628 Fax (603) 673-2273 www.milford.nh.gov conservation@milford.nh.gov



MEMORANDUM

May 21, 2019

To: Milford Planning Board

Re: Interdepartmental Review Map19 Lot 13&14 Family Dental Care Facility Expansion

To the Board,

The Conservation Commission reviewed this plan at their May 9, 2019 meeting. The Commission members have comments.

- 1. The MCC appreciates the extra care taken to design a more natural and aesthetic pleasing structure with the installation of rain gardens to manage the stormwater on site.
- 2. The MCC appreciates the care taken to select native species in the landscaping designs. These are species that will enable the landowner to have a wildlife friendly habitat in addition to a thriving business appearance.

The Commission appreciates the opportunity to review this application. We look forward to seeing a well-designed project that improves the natural resource functionality of the site.

Very Respectfully,

Chris Costantino Milford Conservation Commission | coordinator